

#### GENERAL NOTES

NCC(CURRENT) BCA 2022 VOLUME 2 GENÈRAL

- 1. LEVELS RELATED THE GROUND LEVELS ARE APPROXIMATE ONLY & ARE TO BE CHECKED & VERIFIED ON SITE BY THE BUILDER PRIOR TO COMMENCEMENT OF ANY BUILDING WORKS. WRITTEN DIMENSIONS TAKE PRECEDENCE OVER SCALED DIMENSION.
- 2. REQUIRED FILL & COMPACTION TO BE IN ACCORDANCE WITH AS.2870. ALL UNRETAINED BATTERS/EARTHWORKS ARE TO COMPLY WITH PART 3.2.1 OF THE ABCB
- ALL WORKS INCLUDING BRICKS, BRICKWORK, CONCRETE SLABS & FOOTINGS SHALL COMPLY WITH THE REQUIREMENTS OF THE RELEVANT AUSTRALIAN STANDARDS.
- ALL MATERIALS AND WORK PRACTICES SHALL COMPLY WITH, BUT NOT LIMITED TO, THE BUILDING REGULATIONS 2018, NATIONALCONSTRUCTION CODE CURRENT SERIES BUILDING CODE OF AUSTRALIA VOL 2 AND ALL RELEVANT CURRENT AUSTRALIAN STANDARDS (AS AMENDED) REFERRED TO THEREIN
- UNLESS OTHERWISE SPECIFIED, THE TERM BCA SHALL REFER TO NATIONAL CONSTRUCTION CODE CURRENT SERIES BUILDING CODE OF AUSTRALIA VOLUME 2.
- 6. ALL MATERIALS AND CONSTRUCTION PRACTICE SHALL MEET THE PERFORMANCE REQUIREMENTS OF THE BCA. WHERE A PERFORMANCE SOLUTION IS PROPOSED, THEN, PRIOR TO IMPLEMENTATION OR INSTALLATION IT MUST BE ASSESSED AND APPROVED BY THE RELEVANT BUILDING SURVEYOR AS MEETING THE PERFORMANCE REQUIREMENTS OF THE BCA.
- THESE DRAWINGS SHALL BE READ IN CONJUNCTION WITH ANY HOUSE ENERGY RATING (HERS) REPORT AND SHALL BE CONSTRUCTED IN ACCORDANCE WITH THE STAMPED PLANS ENDORSED BY THE ACCREDITED THERMAL PERFORMANCE ASSESSOR WITHOUT ALTERATION.
- ALL STEPS AS REQUIRED DUE TO SITE CONDITIONS ARE TO BE IN ACCORDANCE WITH AS 3786 WITH BCA PART 11.2
- STEP SIZES (OTHER THAN FOR SPIRAL STAIRS) TO BE
- RISERS (R) 190mm MAXIMUM AND 115mm MINIMUM
- GOING (G) 355mm MAXIMUM AND 240mm MINIMUM 2R + 1G = 700mm MAXIMUM AND 550mm MINIMUM
- WITH LESS THAN 125mm GAP BETWEEN OPEN TREADS, ALL TREADS, LANDINGS AND THE LIKE TO HAVE A SLIP-RESISTANCE CLASSIFICATION OF P3 OR R10 FOR DRY SURFACE CONDITIONS AND P4 OR R11 FOR WET SURFACE CONDITIONS. OR A NOSING STRIP WITH A SLIP RESISTANCE CLASSIFICATION OF P3 FOR DRY SURFACE CONDITIONS AND P4 FOR WET SURFACE CONDITIONS

PROVIDE BARRIERS WHERE CHANGE IN LEVEL EXCEEDS 1000mm ABOVE THE SURFACE BENEATH LANDINGS, RAMPS AND/OR TREADS. BARRIERS (OTHER THAN TENSIONED WIRE BARRIERS) TO BE-

- 1000mm MIN ABOVE FINISHED SURFACE LEVEL OF BALCONIES, LANDINGS OR THE LIKE.
- 870mm MIN. ABOVE FINISHED SURFACE LEVEL OF STAIR NOSING OR RAMP AND VERTICAL WITH LESS THAN 125mm GAP BETWEEN. AND
- A BARRIER, EXCEPT A WINDOW SERVING AS A BARRIER MUST BE DESIGNED TO TAKE LOADING FORCES IN ACORDANCE WITH AS/NZS 1170.1
- CONTINUOUS HANDRAILS TO BE CONSTRUCTED ON ONE SIDE OF THE FLIGHT OF THE STAIRCASE, LOCATED ALONG THE FULL LENGTH OF THE FLIGHT OF STAIRWAYS AND FIXED AT A HEIGHT OF 865mm VERTICALLY ABOVE NOSING OF THE STAIRS TREADS HAVE NO OBSTRUCTIONS AND CONSTRUCTED IN ACCORDANCE WITH PART 11.3.5 OF THE ABCB HOUSING PROVISIONS.
- WHERE BARRIERS ARE FIXED TO THE VERTICAL FACE FORMING AN EDGE OF A LANDING BALCONY, DECK, STAIRWAY OR THE LIKE, THE OPENING FORMED BETWEEN THE BARRIER AND THE FACE MUST NOT EXCEED 40mm IN ACCORDANCE WITH PART 11.3.4 OF THE ABCB HOUSING PROVISIONS.
- IN ACCORDANCE WITH PART 8.4.6 OF THE ABCB HOUSING PROVISIONS, IF A FIXED VANITRY/BENCH/CABINETS IN FRONT OF MIRRORS & SPLASH BACKS DO NOT ACHIEVE THE FOLLOWING DIMENSIONS, MONOLIHTIC ANNEALED GLASS CANNOT BE USED: - NOT LESS THAN 760mm IN HEIGHT, DEPTH NOT LESS THAN 300mm AND EXTENDING THE **FULL** WIDTH OF THE SPLASHBACK/MIRROR
- WHERE THE BUILDING (EXCLUDES A DETACHED CLASS 10) IS LOCATED IN A TERMITE PRONE AREA, THE BUILDING IS TO BE PROVIDED WITH A TERMITE MANAGEMENT SYSTEM.
- STORMWATER

100mm DIA. CLASS 6 UPVC SFALED/CHARGED STORMWATER LINE LAID TO A MINIMUM GRADE OF 1:100 AND CONNECTED TO NOMINATED RAINWATER TANKS WITH THE OVERFLOW DIRECTED TO LEGAL POINT OF STORMWATER DISCHARGE. PROVIDE INSPECTIONOPENINGS AT 9000mm C/C AND AT EACH CHANGE OF DIRECTION.

- THE COVER TO UNDERGROUND STORMWATER DRAINS SHALL BE NOT LESS THAN
- · 100mm UNDFR SOII
- 50mm UNDER PAVED OR CONCRETE AREAS
- 100mm UNDER UNREINFORCED CONCRETE OR PAVED DRIVEWAYS

- 75mm under unreinforced concrete driveways Downpipes must not serve more than 12m of Gutter Length in Accodance with PART 7.4 OF THE ABCB HOUSING PROVISIONS, BOX GUTTERS, RAINHEADS & SUMPS TO BE CONSTRUCTED IN ACCOARDANCE WITH AS3500.3-2021. TEMPORARY DOWNPIPES TO BE CONSTRUCTION TO PREVENT WATER PONDING NEAR FOOTINGS. INSTALLED DURING

ALL STORMWATER TO BE TAKEN TO THE LEGAL POINT OF DISCHARGE TO THE RELEVANT AUTHORITIES APPROVAL.

BUILDINGS IN MARINE, OR EXPOSURE ENVIRONMENTS SHALL HAVE MASONRY UNITS, MORTAR AND ALL BUILT IN COMPONENTS AND THE LIKE COMPLYING WITH THE DURABILITY REQUIREMENTS OF TABLE 4.1 OF AS 4773.1-2015 'MASONRY IN SMALL BUILDINGS' PART 1: DESIGN.

CLASS 3 OR CLASS 4 VAPOUR PERMEABLE MEMBRANES ARE TO BE INSTALLED TO ALL EXTERNAL WALLS, INCLUDING IN FILLS ABOVE WINDOWS & DOORS TO BE COMPLIANT WITH AS 4200.1 & TO BE INSTALLED IN ACCORDANCE WITH AS4200.2

- THESE DRAWINGS SHALL BE READ IN CONJUNCTION WITH ALL RELEVANT STRUCTURAL AND ALL OTHER CONSULTANTS DRAWINGS/DETAILS AND WITH ANY OTHER WRITTEN INSTRUCTIONS ISSUED IN THE COURSE OF THE CONTRACT.
- THE BUILDER SHALL TAKE ALL STEPS NECESSARY TO ENSURE THE STABILITY AND GENERAL WATER TIGHTNESS OF ALL NEW AND/OR EXISTING STRUCTURES DURING ALL WORKS.
- 16. THE BUILDER AND SUBCONTRACTORS SHALL CHECK AND VERIFY ALL DIMENSIONS, SETBACKS, LEVELS AND SPECIFICATIONS AND ALL OTHER RELEVANT DOCUMENTATION PRIOR TO THE COMMENCEMENT OF ANY WORKS. REPORT ALL DISCREPANCIES TO THIS OFFICE FOR CLARIFICATION
- INSTALLATION OF ALL SERVICES SHALL COMPLY WITH THE RESPECTIVE SUPPLY
- THE BUILDER AND SUBCONTRACTOR SHALL ENSURE THAT ALL STORMWATER DRAINS, SEWER PIPES AND THE LIKE ARE LOCATED AT A SUFFICIENT DISTANCE FROM ANY BUILDINGS FOOTINGS AND/OR SLAB EDGE BEAMS SO AS TO PREVENT GENERAL MOISTURE PENETRATION DAMPNESS, WEAKENING AND UNDERMINING OF ANY BUILDING AND ITS FOOTING SYSTEM
- THESE PLANS HAVE BEEN PREPARED FOR THE EXCLUSIVE USE BY THE CLIENT (THE BUILDER - 'HUDSON RIDGE') FOR THE PURPOSE EXPRESSLY NOTED TO THE DESIGNER. ANY OTHER PERSON WHO USES OR RELIES ON THESE PLANS WITHOUT THE DESIGNERS WRITTEN CONSENT DOES SO AT THEIR OWN RISK AND NO RESPONSIBILITY IS ACCEPTED BY THE DESIGNER FOR SUCH USE AND/OR RELIANCE
- A BUILDING PERMIT IS REQUIRED PRIOR TO THE COMMENCEMENT OF THESE WORKS. THE RELEASE OF THESE DOCUMENTS IS CONDITIONAL TO THE OWNER OBTAINING THE REQUIRED BUILDING PERMIT.
- 21. THE CLIENT AND/OR THE CLIENTS BUILDER SHALL NOT MODIFY OR AMEND THE PLANS WITHOUT THE KNOWLEDGE AND CONSENT OF HUDSON RIDGE DRAFTING DEPARTMENT EXCEPT WHERE A REGISTERED BUILDING SURVEYOR MAKES MINOR NECESSARY CHANGES TO FACILITATE THE BUILDING PERMIT APPLICATION AND THAT SUCH CHANGES ARE PROMPTLY REPORTED BACK TO HUDSON RIDGE DRAFTING DEPARTMENT
- 22. THE APPROVAL BY THIS OFFICE OF A SUBSTITUTE MATERIAL, WORK PRACTICE, VARIATION OR THE LIKE. IS NOT AN AUTHORISATION FOR ITS USE OR A CONTRACT VARIATION. ALL VARIATIONS MUST BE ACCEPTED BY ALL PARTIES TO THE AGREEMENT AND WHERE APPLICABLE THE RELEVANT BUILDING SURVEYOR PRIOR TO IMPLEMENTING ANY VARIATION
- SOLAR PANELS ARE TO BE FOR HWS UNLESS OTHERWISE NOTED OR SHOWN BY HUDSON RIDGE.
- IN ACCORDANCE WITH PART 10.8.2 OF THE HOUSING PROVISIONS, ALL EXHAUST FANS FLOOR RATES AND DISCHARGE:

MIN: 25L/s FOR BATHROOMS OR SANITARY COMPARTMENTS

MIN: 40L/s FOR KITCHEN AND LAUNDRY
ALL EXHAUST FANS FROM KITCHEN, KITCHEN RANGE HOOD, BATHROOMS, SANITARY COMPARTMENTS & LAUNDRIES TO DISCHARGE DIRECTLY TO OUTDOOR AIR.

- WATER PROOFING TO BE IN ACCORDANCE WITH PART 10.2 OF THE ABCB HOUSING PROVISIONS.
- BUSHFIRE ASSESMENT: REFER BUSH FIRE ASSESMENT DOCUMENT CONSTRUCTION IN BUSHFIRE PRONE AREAS IN ACCORDANCE WITH AS3959 - 2018.
  - SITE CLASSIFICATION: REFER TO ENGINEERS SOIL REPORT
- 28. CORROSION PROTECTION OF BUILT-IN STRUCTURAL MEMBERS: PROVIDE CORROSION PROTECTION OF BUILT-IN STRUCTURAL STEEL MEMBERS SUCH AS

STEEL LINTELS, SHELF ANGLES, CONNECTORS ACCESSORIES (OTHER THAN WALL TIES) IN ACCORDANCE WITH TABLE 4.1 OF AS 4773.1 - 2015 MASONRY IN SMALL BUILDINGS, PART DESIGN

SUITABLE FOR AN ENVIRONMENT CLASSIFICATION OF: MILD 4.3.2 CORROSION PROTECTION FOR SHEET ROOFING PROVIDE CORROSION PROTECTION FOR SHEET ROOFING IN ACCORDANCE WITH BCA TABLE 7.2.2.A

STRUTURAL STEEL MEMBERS THAT ARE NOT BUILT IN TO A A MASONRY WALL MUST (a) BE PROTECTED AGAINST CORROSION IN ACCORDANCE WITH TABLES 6.3.9a, 6,6,9b & 6.3.9c: AND (b)

WHERE A PAINT FINISH IS APPLIED TO THE SURFACE, BE FREE FROM RUST; AND (c) WHERE **7INC COATINGS** 

ARE APPLIED TO THE SURFACE, BE PROVIDED WITH A BARRIER COAT TO PREVENT DOMESTIC

FROM PEELING; AND (d) WHEN CUT OR WELFED ON-SITE, HAVVE THOSE AREAS AND ANY OTHER AREAS OF DAMAGE TO PROTECTIVE COATINGS COMPLY WITH (a).

SANITARY COMPARTMENTS WITH LESS THAN 1200mm BETWEEN CLOSET PANS & DOORWAYS , SHALL HAVE EITHER

a) A DOOR OPENING OUTWARDS

b) A CAVITY SLIDING DOOR

c) A DOOR FITTED WITH LIFT OFF HINGES

- 30. SMOKE DETECTORS TO BE INSTALLED IN ACCORDANCE WITH AS 3786 AND COMPLY WITH PART9.5 AS REFERENCED IN BCA 2022. ALL SMOKE DETECTORS TO BE HARDWIRED & NTFRCONNECTED
- 31. ALL BRICKWORK TO COMPY WITH AS, 3700 (WHERE USED)

1:1:6 MORTAR, WEEPHOLES EVERY 4TH PERP ON THE FIRST COURSE LEAR OF FINISHED GROUND LEVEL, METAL WALL TILES TO AS. 2699 PACAED AT 460mm HORIZONTALLY AND 610mm VFRTICALLY

- 32. IF BUILDING IN A TERMITE PRONE AREA THE BUILDING (EXCLUDING A DETACHED CLASS 10) THE AREA TO THE UNDERSIDE OF THE BUILDING AND PERIMETER IS TO BE TERMITE
- 33. SUPPLY & INSTALLATION OF ALL LIGHTWEIGHT MATERIALS & CLADDINGS TO BE IN STRICT ACCORDANCE WITH THE MANUFACTURERS DETAIL
- 34. REFER TO THE THERMAL PERFOMANCE ASSESMENT FOR ALL INSULATION MATERIAL & GLAZING REQUIREMENTS ALL NOMINATED MATERIAL PRODUCTS MUST BE INSTALLED IN STRICT ACCORDANCE THE THE FINAL 6 STAR CERTIFICATE

ALL CONCRETE TO HAVE A STRENGTH OF 20MPa

ALL SLAB, BEAM & FOOTING CONCRETE REINFORCEMENT TO BE IN ACCORDANCE WITH RELEVANT AUSTRALIAN STANDARDS A.S. 2870. 1-2011

LAPPING AND SUPPORT OF REINFORCEMENT TO BE IN ACCORDANCE WITH RELEVANT AUSTRALIAN STANDARDS AS NOTED ABOVE. ALLOWABLE BEARING PRESSURE OF SOIL UNDER STRIP OR PAD FOOTINGS - 100

UNDER SLABS OR BEAMS - 50 KPa

POLYTHENE MEMBRANE TO BE LAPPED A MINIMUM OF 200mm AT JOINTS & SHALL BE TAPED AROUND PIPES WHICH PENETRATE THE SLAB.

TOP-SOIL CONTAINING ORGANIC MATTER SHALL BE REMOVED FROM THE

SURFACE WATER MUST BE DIVERTED AWAY FROM CLASS 1 BUILDINGS IN ACCORDANCE WITH PART 3.3.3 OF THE ABCB HOUSING PROVISIONS AS FOLLOWS:

a) SLAB ON GROUND-FINISHED GROUND SLAB HEIGHTS: - THE EXTERNAL FINISHED SURFACE SURROUNDING THE SLAB MUST BE DRAINED TO MOVE SURFACE WATER AWAY FROM THE BUILIDING AND GRADED TO GIVE A SLOPE OF NOT LESS THAN 50mm OVER FIRST

b) SLAB ON GROUND-FINISHED SLAB HEIGHTS: - THE HEIGHT OF THE SLAB ON GROUNG ABOVE EXTERNAL FINISHED SURFACES MUST NOT BE LESS 50mm ABOVE IMPERMEABLE (PAVED OR CONCRETED AREAS) THAT SLOPE AWAY FROM THE BUILDING IN ACCORDANCE WITH

THE HEIGHT OF THE SLAB ON GROUND ABOVE EXTERNAL FINISHED SURFACES IN LOW RAIN INTENSITY AREAS OR SANDY, WELL-DRAINED AREAS MUST BE NOT LESS THAN THE SLOPE AWAY

150mm IN ANY OTHER CASE

CONCRETE SLAB TO ENGINEERS DESIGN

WINDOWS & GLAZED DOORS & GLAZING IN GENERAL

GLASS IN A BUILDING MUST BE IN ACCOARDANCE WITH AS 1288:2021

1. ALL EXTERNAL WINDOWS AND GLAZED DOORS TO BE ALUMINIUM FRAMED UNLESS OTHERWISE NOTED AND IN ACCORDANCE WITH AS 2047 - 2014. WINDOWS & GLASS SLIDING DOORS ARE TO BE CENTERED TO ROOM UNLESS

OTHERWISE NOTED. IN ACCORDANCE WITH PART 8.4.8 OF THE ABCB HOUSING PROVISIONS, ALL Safety glazing must be marked in form of permanent etching or a label that

CANNOT BE REUSED ONCE REMOVED. THE LABEL MUST SPECIFY THE FOLLOWING: . THE AUSTRALIAN STANDARD TO THE SAFETY GLASS WAS TESTED

REGISTERED NAME OF THE MANUFACTURER OR SUPPLIER GRADE OF SAFETY GLASS

NOMINAL THICKNESS OF THE SAFETY GLASS & THE TYPE OF SAFETY GLASS

GLAZING IN KITCHENS, BATHROOMS, ENSUITES, SHOWER SCREENS BATH ENCLOSURES AND ANY WINDOWS & DOORS (INCLUDING CABINET DOORS), WHERE THE LOWEST SIGHT LINE IS LESS THAN 2M (INCLUDING BOTTOM OF BATH OR SHOWER BASE) will have grade a safety glass if framed panels & panelsor doors with edges EXPOSED, WILL BE A MIN.6mm TOUGHENED SAFETY GLASS IN ACCORDANCE WITH PART

8.4.6 OF THE ABCB HOUSING PROVISIONS GLAZING IN KITCHENS, BATHROOMS, ENSUITES, SHOWER DOORS, SHOWER SCREENS BATH ENCLOSURES & ANY WINDOWS & DOORS (INCLUDING CABINET DOORS), WHERE THE LOWEST SIGHT LINE IS LESS THAN 2M(INCLUDING BOTTOM OF BATH OR

SHOWER BASE) WILL HAVE GRADE A SAFETY GLASS IF FRAMED PANELS & PANELS OR DOORS WITH EDGES EXPOSED, WILL BE A MIN. 6mm TOUGHENED SAFETY GLASS IN ACCORDANCE WITH PART 8.4.6 OF THE ABCB HOUSING PROVISIONS.

SAFETY GLAZING SHALL BE USED IN THE FOLLOWING CASES:-

a) ALL ROOMS - WITHIN 500mm OF VERTICAL FLOOR b) BATHROOMS - WITHIN 2000mm VERTICAL OF BATH BASE & ENSUITES WITHIN 2000mm HORIZONTAL OF BATH/SHOWER TO SHOWER DOORS, SHOWER SCREENS & BATH **FNCLOSURES** 

c) LAUNDRY - WITHIN 1200mm VERTICAL OF FLOOR & WITHIN 300mm VERTICAL OF TROUGH d) DOORWAYS - WITHIN 300mm HORIZONTAL OF ALL DOORS . GLAZING INCLUDING SAFETY GLAZING SHALL BE INSTALLED TO A SIZE TYPE AND

THICKNESS SO AS TO COMPLY WITH BCA/NCC PART 8 FOR CLASS 1 & 10 BUILDINGS WITHIN A DESIGN WIND SPEED OF NOT MORE THAN N3 AS PER AS 1288-2021 AND BCA 2022/ABCB HOUSING PROVISIONS

ROOF STRUCTURE

1. ROOF STRUCTURE TO BE DESIGNED IN ACCORDANCE WITH WIND LOADING AS

CEILING BATTENS TO BE 25mm 'TOP-HAT' SECTION

ROOFING MATERIAL AS NOTED ON ELEVATIONS & PLAN

REFER TO BUILDING CONTRACTS FOR DOWNPIPE SPECIFICATIONS BE IN ACCORDANCE WITH AS/NZS 3500.3.2021

COLORBOND - CUSTOM ORB SHEET ROOF ABOVE 5 DEGREE ROOF PITCH - KLIP LOK OR TRIMDECK BELOW 5 DEGREES

FIXED TO TOP HAT ROOF BATTENS @ 900CTRS ON TIMBER TRUSSES @900CTRS BRACE & TIE DOWN TO MANUFACTURERS SPECIFICATION - MNUFACTURER TO SUPPLY COMPUTATIONS & DETAILS TO BUILDING SURVEYOR

#### WALL FRAMING

FOR STRUCTURAL DETAILS AS 1684.2 2021 TIMBER FRAMING DESIGN MANUAL FOR ACTUAL CONFIGURATION & RACKING CAPACITY OF EACH TYPE OF BRACED PANEL REFER TO THE AS 1684.2010 TIMBER FRAMING MANUAL

3. WALL FRAMES DESIGNED & CONSTRUCTED IN ACCORDANCE WITH WIND LOADING AS SPECIFIED IN SITE REPORT ASSESSMENT

WALL FRAMING- & LINTELS ARE TO BE PRE-FABRICATED BY FRAMING MANUFACUTERS TO RELEVANT AUSTRALIAN STANDARDS- MANUFACTURER TO SUPPLY **OWNER & BUILDING SURVEYOR SPECIFICATIONS** 

SITE FEATURES AND LEVELS TO BE CONFIRMED PRIOR TO CONSTRUCTION WORKS COMMENCEMENT

#### **AUTHORITIES / CONSULTANTS:**

MUNICIPALITY - CITY OF GREATER GEELONG / SURF COAST SHIRE / CITY OF BALLARAT SEWERAGE AUTHORITY - BARWON WATER CENTRAL HIGHLANDS WATER ELEVANT BUILDING SURVEYOR - SAM CLARK (INFORM BUILDING PERMITS) CONSULTING TOWN PLANNER - NON APPLICABLE
CONSULTING STRUCTURAL ENGINEER - STRUCTERRE Thermal Performance Assessor - Greg o'beirne

#### RESCODE REQUIREMENTS: PART 5: SITING

75 BLIII DING HEIGHT

75 BOILDING REIGHT
REFER TO ELEVATIONS FOR OVERALL HEIGHT
(THE OVERALL HEIGHT = LESS THAN 7.5m/9m MAX.
DEPENDING ON AREA) REFER TO SITE PLAN

76 SITE COVERAGE TOTAL BUILDING FOOTPRINT = REFER TITLE PANEL
REFER TITLE PANEL FOR SITE COVERAGE (MAX 60% OF ALLOTMENT AREA)

REFER TO TITLE PANEL FOR SITE/HOUSE ALLOW MIN. 20% AREA OF IMPERVIOUS SURFACE

78 CARPARKING REFER DRAWINGS ON THIS PAGE FOR PROPOSED CAR

SPACE LOCATIONS AND SIZES 79 SIDE AND REAR SETBACKS

REFER TO DRAWING ON THIS PAGE FOR PROPOSED RESIDENCE SETBACKS FROM BOUNDARIES. REFER TO ELEVATIONS FOR SETBACK WALL HEIGHT RELATIONSHIP. (PARAPET WALL HEIGHT LESS THAN OR EQUAL TO 3.2m MAXIMUM ALLOWABLE ENCROACHMENT INTO SETBACK DISTANCE)

80 WALLS ON BOUNDARIES INCLUDING WALLS ON OR WITHIN 200mm OF BOUNDARY
MAXIMUM LENGTH ALLOWABLE 10m (UNO BY RESTRICTIVE COVENANT) PLUS 25% OF

81 DAYLIGHT TO EXISTING HABITABLE ROOM WINDOWS REFER TO THE DRAWING ON THIS PAGE FOR THE LOCATION OF EXISTING HABITABLE ROOM WINDOWS ON ADJACENT ALLOTMENTSAND THE SETBACK DISTANCE OF THE PROPOSED RESIDENCE FROM THESE WINDOWS

82 SOLAR ACCESS TO EXISTING NORTH FACING WINDOWS REFER TO THE DRAWING ON THIS PAGE FOR THE LOCATION OF EXISTING NORTH FACING WINDOWS ON ADJACENT ALLOTMENTS WITHIN 3m OF THE ALLOTMENT BOUNDARY AND THE PROPOSED SETBACK TO THE NEW RESIDENCE FROM THESE WINDOWS

(APPLICABLE ONLY IF THE HEIGHT OF THE FLOOR IS 800mm ABOVE NATURAL SURFACE LEVEL AT THE BOUNDARY OR WHERE ANY PROPOSED HABITABLE ROOM WINDOW IS NOT OBSTRUCTED BY A FENCE OR SCREEN OF AT LEAST 1.8m IN HEIGHT WITHIN 9.0m OF THE ALLOTMENT BOUNDARY, WHERE THERE IS AN EXISTING DWELLING ON THE ADJOINING

85 DAYLIGHT TO NEW HABITABLE ROOM WINDOWS REFER TO THE DRAWING ON THIS PAGE SHOWING THE PROPOSED SETBACK DISTANCES

SITE AREA = REFER TO SITE PLAN
AREA OF SECLUDED PRIVATE OPEN SPACE (MIN 25m² WITH MIN 3m DIMENSION)
TOTAL PRIVATE OPEN SPACE MIN, 80m² OR 20% OF AREA OF THE ALLOTMENT, WHICHEVER


**HUDSON RIDGE** BUILDERS HUDSON RIDGE BUILDERS 102 FUSSELL STREET, BALLARAT EAST 127 MARSHALLTOWN RD,GROVEDALE

sales@hudsonridge.com.au w: hudsonridge.com.au




ENERAL NOTES	BUILT FORM AREAS AREA DWELLING	SQM 259.02	SQ 27.88	REV
NT NAME: CLIENT NAME	GARAGE PORCH	38.94 3.69	4.19 0.40	IXL V
DJECT ADDRESS: ADDRESS, SUBURB	TOTAL AREA: SITE AREA: SITE COVERAGE	301.65 AREA XX.X%	32.47	
IGN TYPE: GLASSHOUSE 32 ""MEREDITH""	SITE COVERNOE.	***************************************		-

SUSHFIRE RATING - BAL TBC AMENDMENT/DESIGN RELEASE ev. Idate PROJECT NUMBER: OIL CLASSIFICATION - "TRC DATE: 11/10/2024 /IND CLASSIFICATION - "TBC DRAWN RV SA DRAWING NUMBER: 2 OF 21 CHECKED BY PRINTED SHEET SIZE: A3

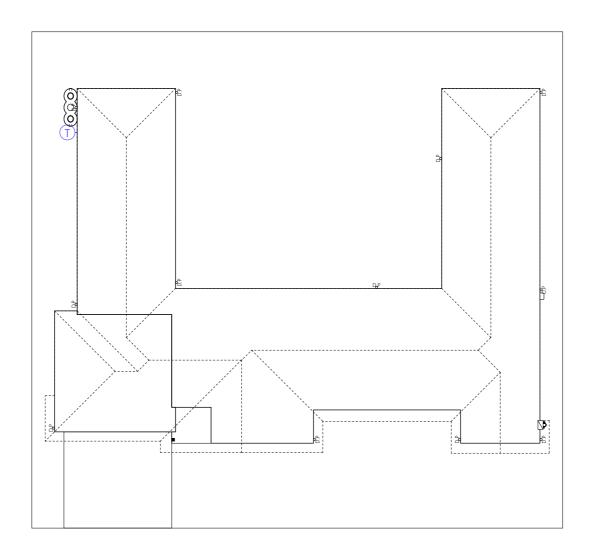

SITE PLAN SCALE 1:200

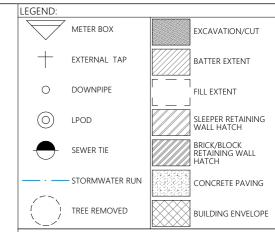

EXCAVATION NOTES:

EXCAVATE APPROX. CUT AS PER R.L. AND SPREAD FILL OVER REMAINING BUILDING AREA TO LEVEL. REFER TO LEVELS ON SITE PLAN FOR STEPDOWNS.

EXCAVATIONS TO START MIN. 1000MM FROM EDGE OF BUILDING AND ARE TO BE BATTERED BACK AT A 45 DEG. MINIMUM.

IF A CONCRETE DRIVEWAY IS NOT PROVIDED IT IS THE OWNERS RESPONSIBILITY TO PROVIDE A GRATED DRAIN ACROSS GARAGE OPENINGS, WHERE REQUIRED.

GENERAL NOTES:

- LOCATION OF GARDEN TAPS TBC ON BY BUILDER ON SITE.


HUDSON RIDGE B U I L D E R S

HUDSON RIDGE BUILDERS 102 FUSSELL STREET, BALLARAT EAST 127 MARSHALLTOWN RD,GROVEDALE




SITE PLAN (NEW)		BUILT FORM AREAS AREA DWELLING	SQM 259.02	SQ 27.88
CLIENT NAME:	CLIENT NAME	GARAGE PORCH	38.94 3.69	4.19 0.40
PROJECT ADDRESS: ADDRESS,		TOTAL AREA:  SITE AREA:  SITE COVERAGE:	301.65 AREA XX.X%	32.47
DESIGN TYPE:	GLASSHOUSE 32 ""MEREDITH""	SHE COVERNOE.	AA.A/6	

REV.	DATE	AMENDMENT/DESIGN RELEASE	PROJECT INDIVIDER.		BUSHFIRE RATING - BAL TBC SOIL CLASSIFICATION - "TBC"
REV #	*ISSUE DATE	*MANUAL TEXT* CONCEPT DESIGN	TC DATE:		WIND CLASSIFICATION - "TBC"
			DRAWN BY:	S A	DRAWING NUMBER: 3 OF 21
			CHECKED BY:		PRINTED SHEET SIZE: A3

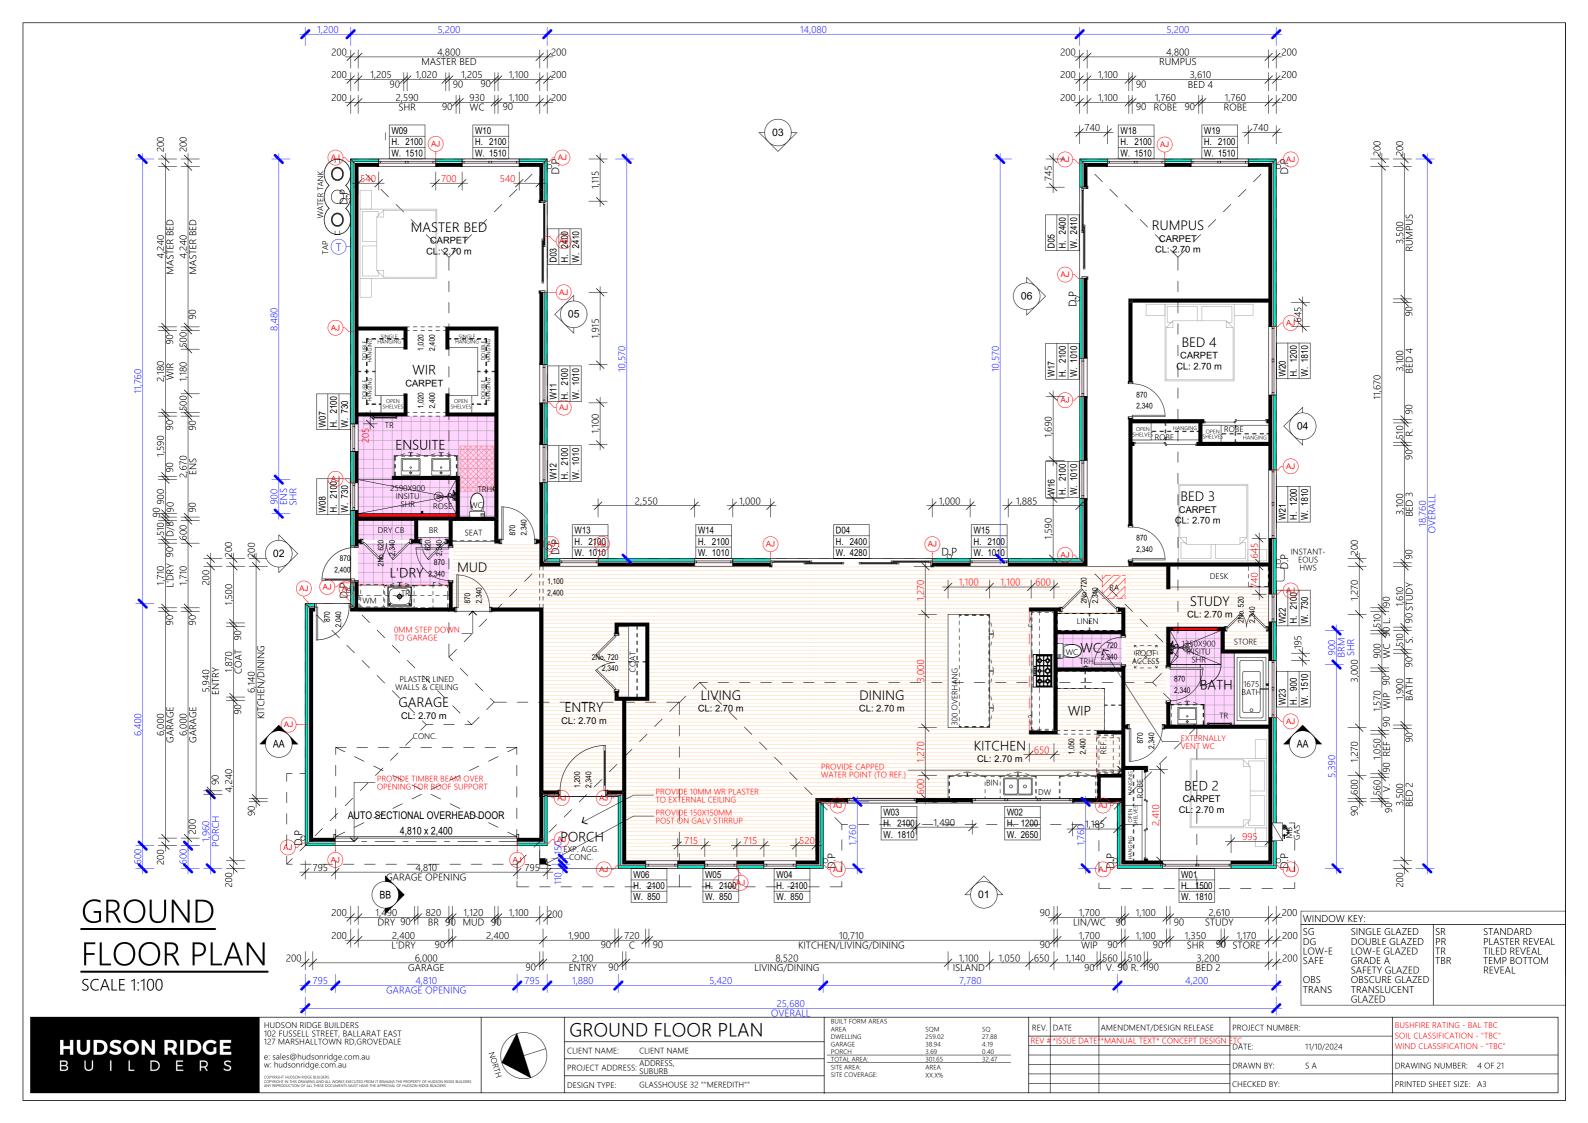



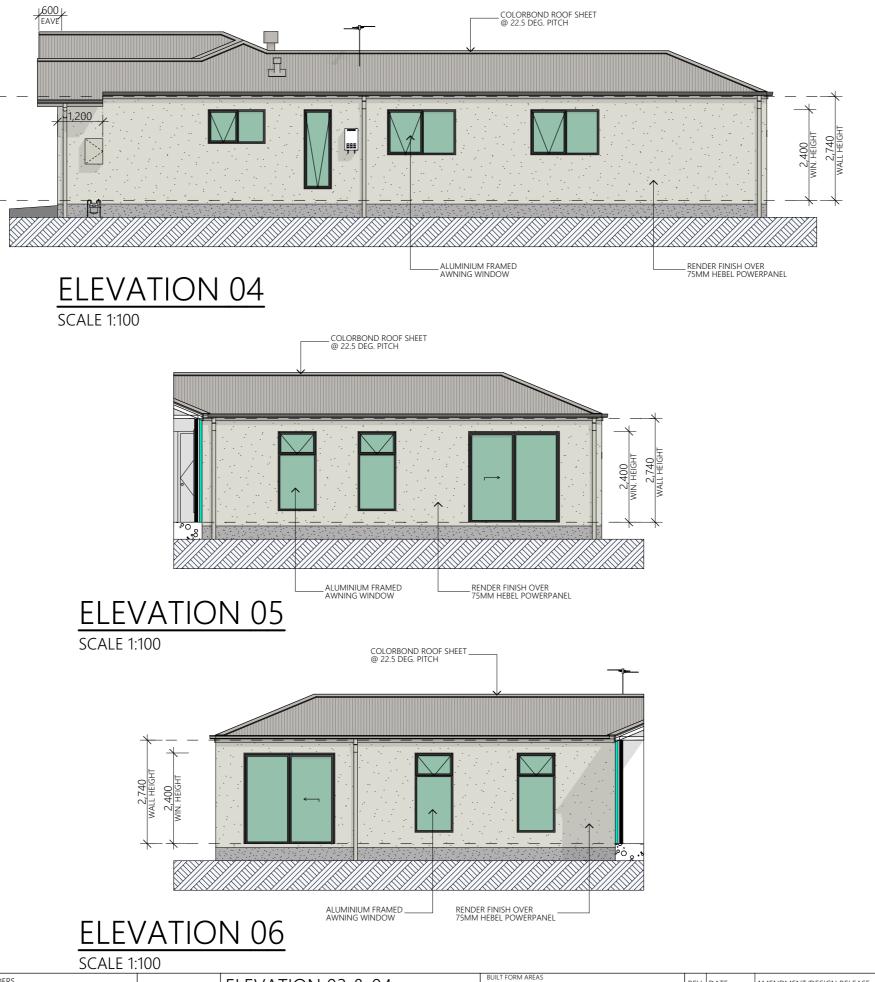

HUDSON RIDGE B U I L D E R S HUDSON RIDGE BUILDERS 102 FUSSELL STREET, BALLARAT EAST 127 MARSHALLTOWN RD,GROVEDALE

e: sales@hudsonridge.com.au w: hudsonridge.com.au

COPRIGHT HUDSON RIDGE BUILDERS
COPRIGHT IN THIS DRAWING, AND ALL WORKS DECUTED FROM IT REMAINS THE PROPERTY OF HUDSON RIDGE BUILDERS
ANY REPRODUCTION OF ALL THESE DOCUMENTS MUST HAVE THE APPROVAL OF HUDSON RIDGE BUILDERS



ELEVATI	ON 03 & 04	BUILT FORM AREAS AREA DWELLING	SQM 259.02	SQ 27.88
LIENT NAME:	CLIENT NAME	GARAGE PORCH	38.94 3.69	4.19 0.40
ROJECT ADDRESS:	ADDRESS, SUBURB	TOTAL AREA:  SITE AREA:  SITE COVERAGE:	301.65 AREA XX.X%	32.47
ESIGN TYPE:	GLASSHOUSE 32 ""MEREDITH""	Site Coverage.	77.70	

			PROJECT NOWIDER.		BUSHFIRE RATING - BAL TBC SOIL CLASSIFICATION - "TBC"	
REV #	*ISSUE DATE	*MANUAL TEXT* CONCEPT DESIGN	TC DATE:		WIND CLASSIFICATION - "TBC"	
			DRAWN BY:	S A	DRAWING NUMBER: 6 OF 21	
			CHECKED BV:		DRINTED SHEET SIZE: A3	

FLYSCREEN NOTES:


FLOOR TO CEILING HEIGHT NOTES:

EAVE NOTES:

- PROVIDE FLYSCREENS TO ALL OPENABLE WINDOWS THROUGHOUT THE DWELLING - PROVIDE FLYDOORS TO ALL SLIDING DOORS

- DIMENSIONS OF EAVE WIDTHS TAKEN FROM THE EXTERNAL SIDE OF THE 90MM STUD FRAME (I.E NOT THE EXTERNAL CLADDING FACE).
- EAVES TO HAVE FLAT SOFFIT UNLESS OTHERWISE STATED (I.E NOT RAKED)

- ACTUAL FINISHED INTERNAL FLOOR TO CEILING HEIGHTS ARE APPROX 40MM LOWER THAN WALL FLOOR TO CEILING HEIGHTS INDICATED ON ELEVATIONS (IE. 2590MM IS 2550MM INTERNALLY)

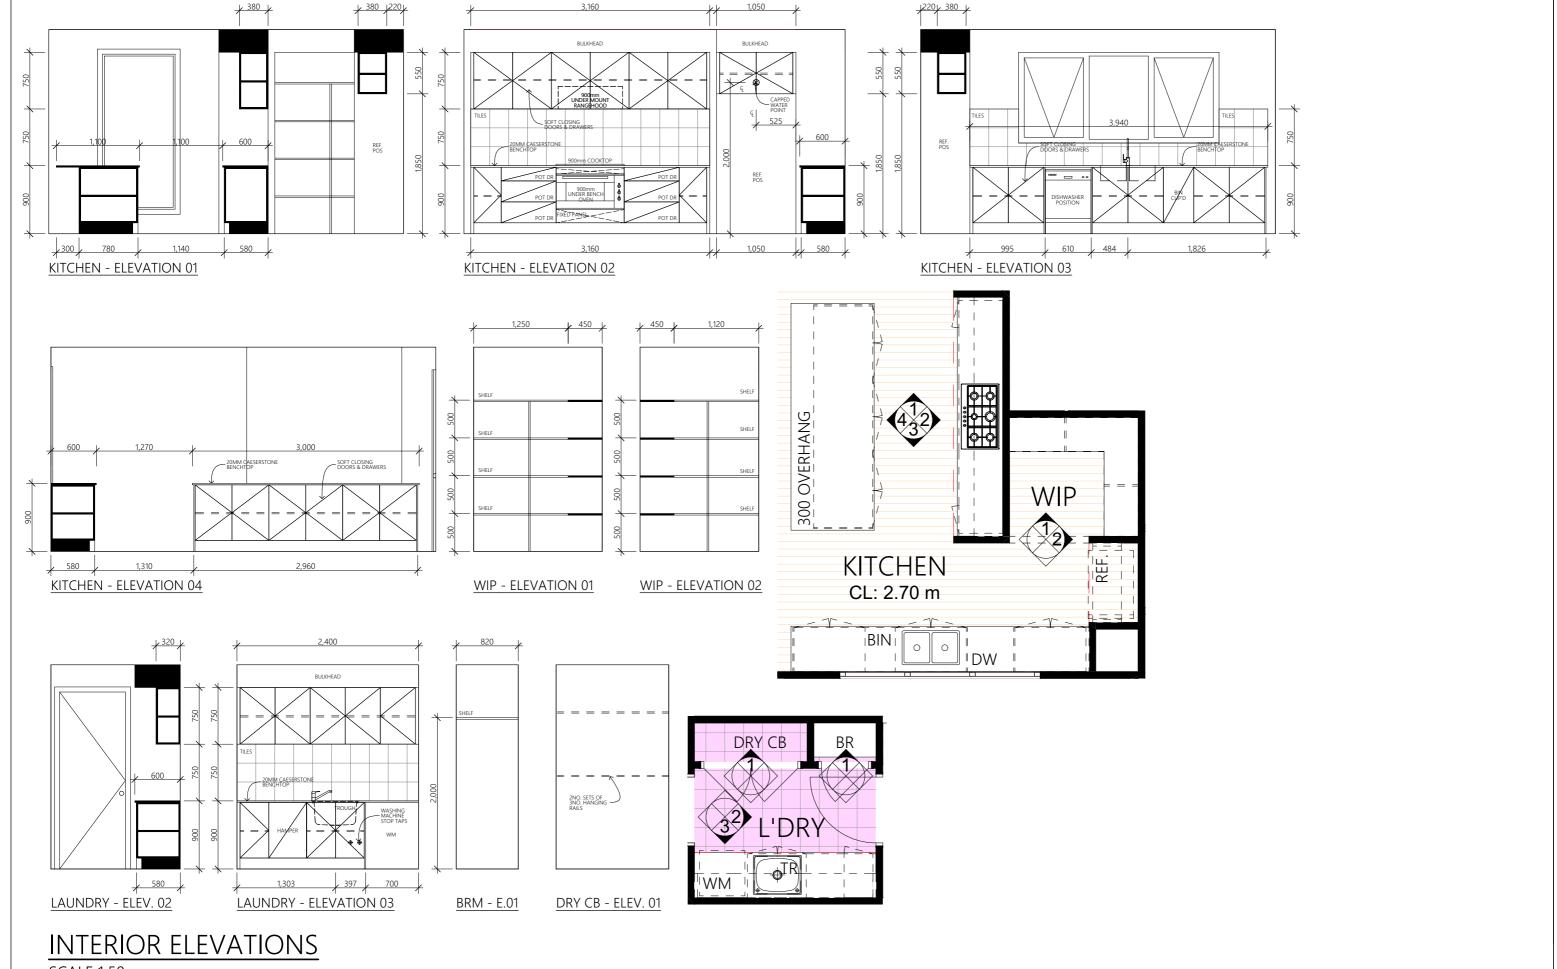

SCALE 1:50

HUDSON RIDGE B U I L D E R S HUDSON RIDGE BUILDERS 102 FUSSELL STREET, BALLARAT EAST 127 MARSHALLTOWN RD,GROVEDALE

n. naasonnage.com.aa
COPPISHH HUDSON BIDGE BUILDERS COPPISHH HI NIS DRANING AND ALL WORKS EXECUTED FROM IT REMAINS THE PROPERTY OF HUDSON RIDGE BUILD ANY REPRODUCTION OF ALL THESE DOCUMENTS MUST HAVE THE APPROVAL OF HUDSON RIDGE BUILDERS

NORTH

NTERIOR ELEVATIONS 01	AREA DWELLING	SQM 259.02	S 2
LIENT NAME: CLIENT NAME	GARAGE PORCH	38.94 3.69	4
ROJECT ADDRESS: ADDRESS, SUBURB	TOTAL AREA: SITE AREA: SITE COVERAGE:	301.65 AREA XX.X%	3
ESIGN TYPE: GLASSHOUSE 32 ""MEREDITH""	SITE COVERAGE.	AA.A70	

REV.	DATE	AMENDMENT/DESIGN RELEASE	PROJECT NOWIBER.		BUSHFIRE RATING - BAL TBC SOIL CLASSIFICATION - "TBC"	
REV #	*ISSUE DATE	*MANUAL TEXT* CONCEPT DESIGN	TC DATE:		WIND CLASSIFICATION - "TBC"	
			DRAWN BY:	SA	DRAWING NUMBER: 7 OF 21	
			CHECKED BY:		PRINTED SHEET SIZE: A3	



HUDSON RIDGE
BULL DERS


S

HUDSON RIDGE
BULL STREET, BALLARAT EAST
127 MARSHALLTOWN RD, GROVEDALE
e: sales@hudsonridge.com.au
w: hudsonridge.com.au
coppedient haddon block bullders
coppedient haddon



INTERIC	OR ELEVATIONS 02	BUILT FORM AREAS AREA DWELLING	SQM 259.02	SQ 27.88
CLIENT NAME:	CLIENT NAME	GARAGE PORCH	38.94 3.69	4.19 0.40
PROJECT ADDRES	s: Address, S: Suburb		301.65 AREA XX.X%	32.47
DESIGN TYPE:	GLASSHOUSE 32 ""MEREDITH""	SITE COVERNOL.	AA.A/6	

REV.	DATE	AMENDMENT/DESIGN RELEASE	PROJECT NOIVIBER.		SOIL CLASSIFICATION - "TBC"
REV #	*ISSUE DATE	*MANUAL TEXT* CONCEPT DESIGN	TC DATE:		WIND CLASSIFICATION - "TBC"
			DRAWN BY:	SA	DRAWING NUMBER: 8 OF 21
			CHECKED BY:		PRINTED SHEET SIZE: A3

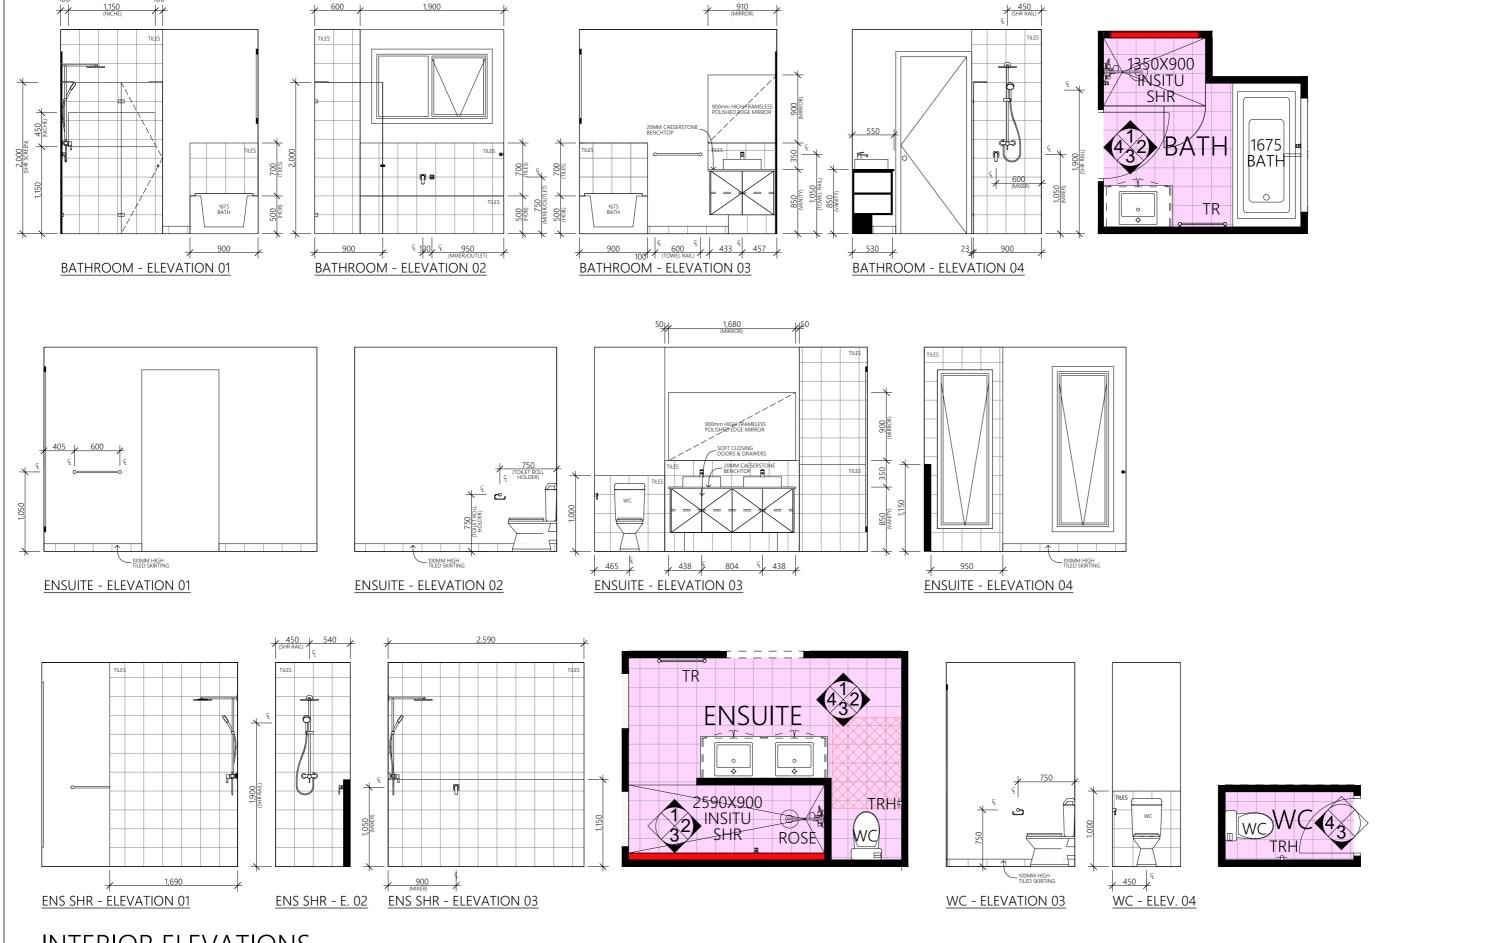

# **INTERIOR ELEVATIONS**

SCALE 1:50

**HUDSON RIDGE**B U I L D E R S


HUDSON RIDGE BUILDERS 102 FUSSELL STREET, BALLARAT EAST 127 MARSHALLTOWN RD,GROVEDALE e: sales@hudsonridge.com.au w: hudsonridge.com.au



NTERIOR ELEVATIONS 03	BUILT FORM AREAS AREA DWELLING	SQM 259.02	9
NT NAME: CLIENT NAME	GARAGE PORCH	38.94 3.69	(
DJECT ADDRESS: ADDRESS, SUBURB	TOTAL AREA: SITE AREA: SITE COVERAGE:	301.65 AREA XX.X%	
GIGN TYPE: GLASSHOUSE 32 ""MEREDITH""	3772 COVENIUE.	AA.A/0	

	BUILT FORM AREAS		
	AREA	SQM	SQ
	DWELLING	259.02	27.88
Т	GARAGE	38.94	4.19
	PORCH	3.69	0.40
+	TOTAL AREA:	301.65	32.47
	SITE AREA:	AREA	
_	SITE COVERAGE:	XX.X%	

	V. DATE		PROJECT NUMBER:		BUSHFIRE RATING - BALTBC SOIL CLASSIFICATION - "TBC"
RE	V # *ISSUE DATE	**MANUAL TEXT* CONCEPT DESIGN	DATE:		WIND CLASSIFICATION - "TBC"
F			DRAWN BY:	S A	DRAWING NUMBER: 9 OF 21
			CHECKED BY:		PRINTED SHEET SIZE: A3

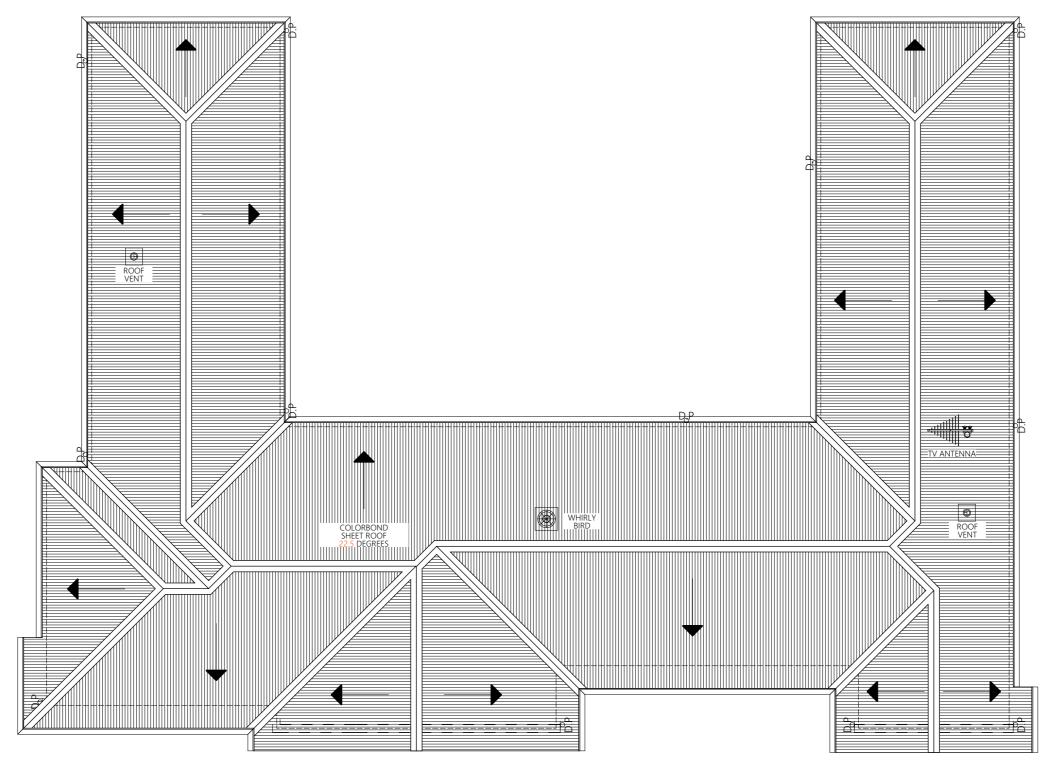

# **ROOF PLAN**

SCALE 1:100

HUDSON RIDGE B U I L D E R S

HUDSON RIDGE BUILDERS 102 FUSSELL STREET, BALLARAT EAST 127 MARSHALLTOWN RD,GROVEDALE


COPYRIGHT HUDSON RIDGE BUILDERS COPYRIGHT IN THIS DRAWING AND ALL WORKS DECUTED FROM IT REMAINS THE PROPERTY OF HUDSON RIDGE BUILDER ANY REPRODUCTION OF ALL THESE DOCUMENTS MUST HAVE THE APPROVAL OF HUDSON RIDGE BUILDERS

	ROOF
Z (A)	CLIENT NAME:
	PROJECT ADDRE
	DESIGN TYPE:

ROOF PLAN	BUILT FORM AREAS AREA DWELLING	SQM 259.02	SQ 27.88
CLIENT NAME: CLIENT NAME	GARAGE PORCH	38.94 3.69	4.19 0.40
Project address: Address, Suburb	TOTAL AREA: SITE AREA: SITE COVERAGE:	301.65 AREA XX.X%	32.47
DESIGN TYPE: GLASSHOUSE 32 ""MEREDITH""	SITE COVERNOL.	AA.A/6	

	I		PROJECT NUMBER:		BUSHFIRE RATING - BAL TBC SOIL CLASSIFICATION - "TBC"
REV #	*ISSUE DATE	**MANUAL TEXT* CONCEPT DESIGN	DATE:		WIND CLASSIFICATION - "TBC"
			DRAWN BY:	S A	DRAWING NUMBER: 10 OF 21
			CHECKED BY:		PRINTED SHEET SIZE: A3

VENTILATION NOTES:
ALL EXHAUST FANS MUST BE VENTED DIRECTLY TO THE OUTSIDE AIR VIA A DUCT SYSTEM.
EXHAUST FAN FLOW RATES REQUIRED:
20 LITRES PER SECOND TO LAUNDRY'S BATHROOM AND WC'S
40 LITRES PER SECOND TO RANGEHOODS

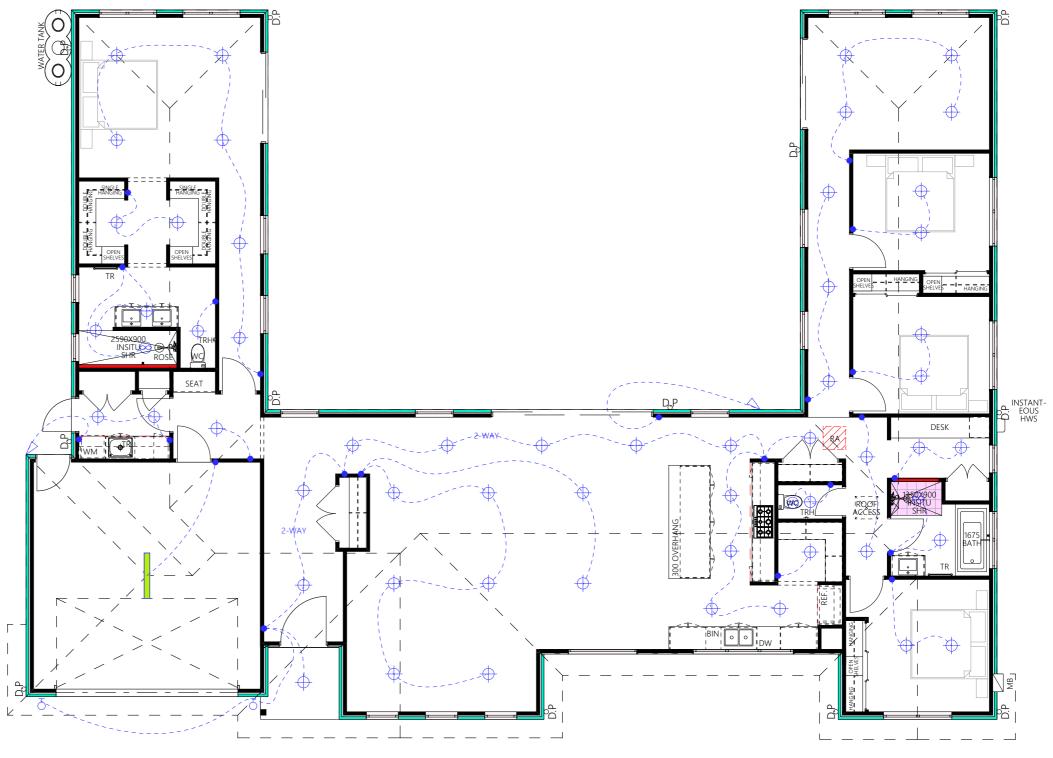

## **ELECTRICAL - LIGHTING** SCALE 1:100

PLEASE NOTE:
ALL ELECTRICAL FITTING/HEATING/COOLING OUTLET LOCATIONS ARE
NOMINAL ONLY. TO BE CONFIRMED AND LOCATED AS PER
MANUFACTURERS SPECIFICATIONS

ARTIFICIAL LIGHTING CALCULATION

LIGHTING LOCATION CLASS 1 BUILDING (5W/m2) RESIDENCE CLASS 10 BUILDING (3W/m2) GARAGE/CARPORT

TOTAL

ICON

Electrical - Internal Lighting

Electrical - Garage Lighting

Electrical - External Lighting

DOWNLIGHT

LED PANEL LIGHT

DOWNLIGHT EXTERNAL SPOTLIGHT

WALL LIGHT FITTING

EXHAUST FAN (DUCTED)

IN ACCORDANCE WITH NCC BUILDING CODE OF AUSTRALIA VOLUME 2 PART 3. 12.5.5

LIGHTING SCHEDULE

DESCRIPTION

ACTUAL (WATTS)

QTY WATT

1 25

18 14


**HUDSON RIDGE**B U I L D E R S

HUDSON RIDGE BUILDERS 102 FUSSELL STREET, BALLARAT EAST 127 MARSHALLTOWN RD,GROVEDALE

COPPRIGHT HUDSON RIDGE BUILDERS COPPRIGHT IN THIS DRAWING AND ALL WORKS EXECUTED FROM IT REMAINS THE PROPERTY OF HUDSON RIDGE BUILDER ANY REPRODUCTION OF ALL THESE DOCUMENTS MUST HAVE THE APPROVAL OF HUDSON RIDGE BUILDERS
---

ELECTR	CAL - LIGHTING	BUILT FORM AREAS AREA DWELLING	SQM 259.02	SQ 27.88
CLIENT NAME:	CLIENT NAME	GARAGE PORCH	38.94 3.69	4.19 0.40
PROJECT ADDRESS	ADDRESS, SUBURB	TOTAL AREA: SITE AREA: SITE COVERAGE:	301.65 AREA XX.X%	32.47
DESIGN TYPE:	GLASSHOUSE 32 ""MEREDITH""	3112 CO 1210102.	AAAA	

ı		1		PROJECT NUMBER:		SOIL CLASSIFICATION - "TBC"
	REV #	*ISSUE DATE	*MANUAL TEXT* CONCEPT DESIGN	TC DATE:		WIND CLASSIFICATION - "TBC"
				DRAWN BY:	SA	DRAWING NUMBER: 11 OF 21
				CHECKED BY:		PRINTED SHEET SIZE: A3

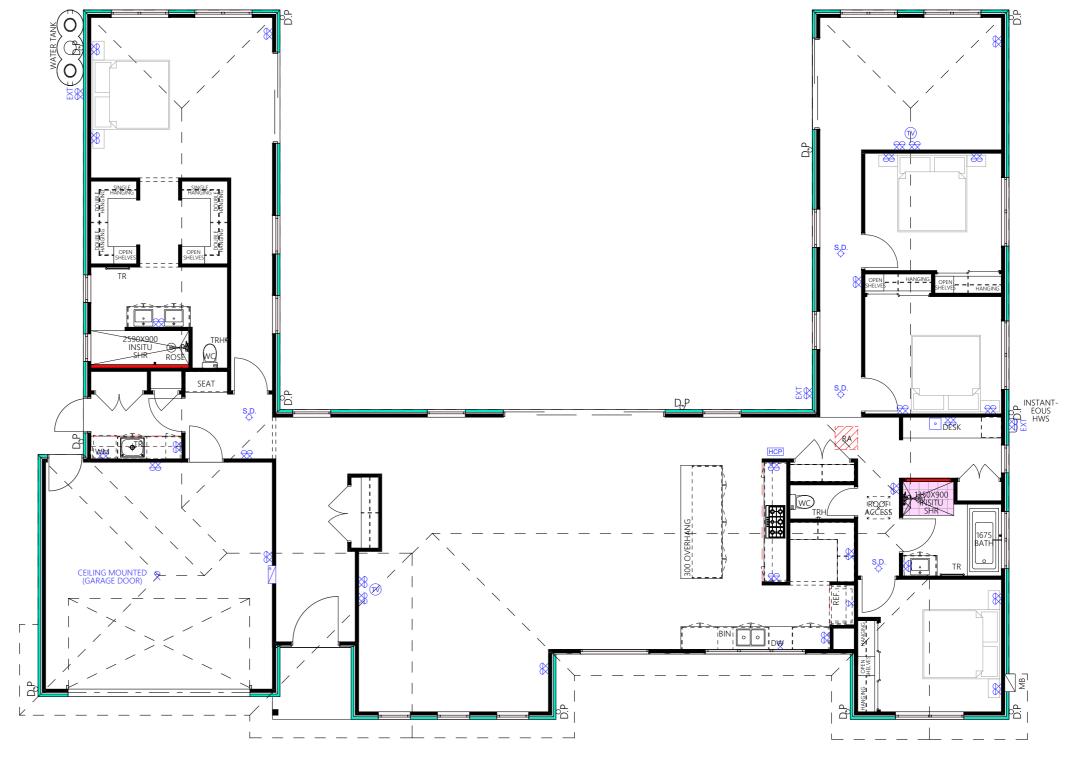

# ELECTRICAL SCHEDULE (ACCESSORIES) ICON DESCRIPTION QTY Electrical Accessories DOUBLE GENERAL POWER OUTLET 29 DOUBLE GENERAL POWER OUTLET (EXTERNAL) 3 B.D. HARDWIRED SMOKE DETECTOR 4 (INTERCONNECTED) 4 HCP HEATING CONTROL PANEL 1 NBN CAT 6 DATA POINT 1 NBN HUB 1 SINGLE GENERAL POWER OUTLET 3

TV POINT

# ELECTRICAL - ACCESSORIES

SCALE 1:100

PLEASE NOTE: ALL ELECTRICAL FITTING/HEATING/COOLING OUTLET LOCATIONS ARE NOMINAL ONLY. TO BE CONFIRMED AND LOCATED AS PER MANUFACTURERS SPECIFICATIONS

> HUDSON RIDGE B U I L D E R S

HUDSON RIDGE BUILDERS 102 FUSSELL STREET, BALLARAT EAST 127 MARSHALLTOWN RD,GROVEDALE


e: sales@hudsonridge.com.au w: hudsonridge.com.au

COPYRIGHT HUDSON RIDGE BUILDERS
COPYRIGHT IN THIS DRAWING AND ALL WORKS EXECUTED FROM IT REMAINS THE PROPERTY OF HUDSON RIDGE BUILDERS
ANY REPRODUCTION OF ALL THESE DOCUMENTS MUST HAVE THE APPROVAL OF HUDSON RIDGE BUILDERS

OR T
------

<b>ELECTRI</b>	CAL - ACCESSORIES	AREA DWELLING	SQM 259.02	SC 27
CLIENT NAME:	CLIENT NAME	GARAGE PORCH	38.94 3.69	4.1 0.4
PROJECT ADDRESS	. ADDRESS,	TOTAL AREA: SITE AREA:	301.65 AREA	32
DESIGN TYPE:	GLASSHOUSE 32 ""MEREDITH""	SITE COVERAGE:	XX.X%	

REV.	DATE	AMENDMENT/DESIGN RELEASE	PROJECT NUMBER:		BUSHFIRE RATING - BAL TBC SOIL CLASSIFICATION - "TBC"
REV #	*ISSUE DATE	*MANUAL TEXT* CONCEPT DESIGN	TC DATE:		WIND CLASSIFICATION - "TBC"
			DRAWN BY:	S A	DRAWING NUMBER: 12 OF 21
			CHECKED BY:		PRINTED SHEET SIZE: A3

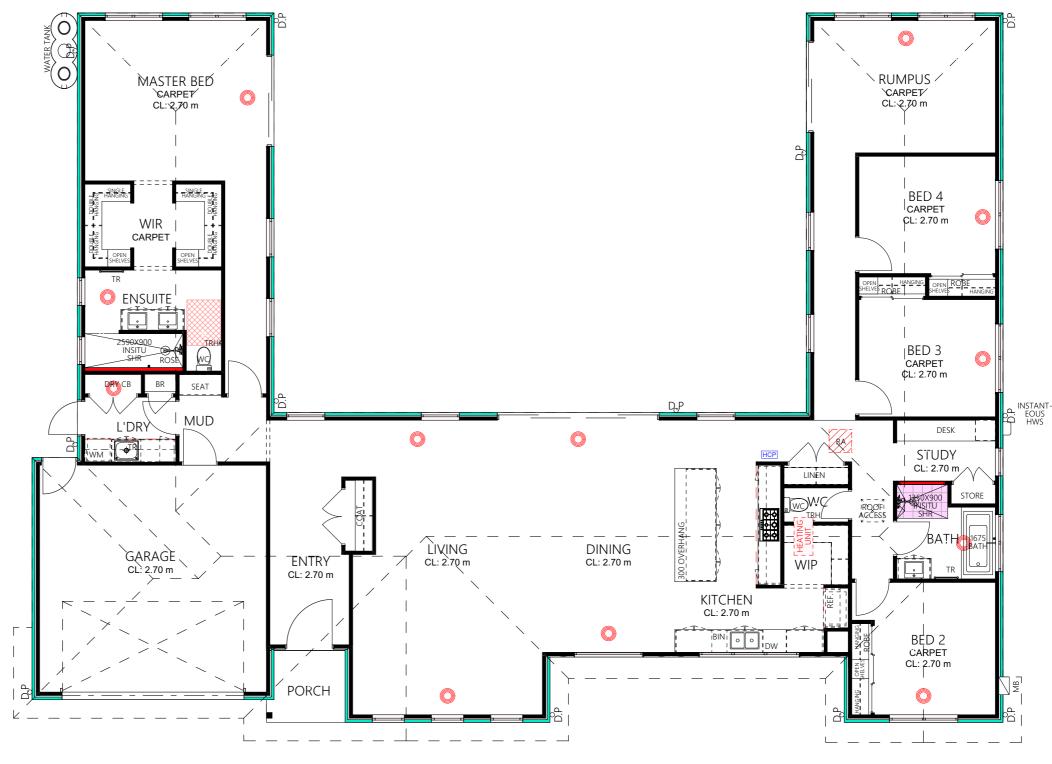

ICON DESCRIPTION QTY

Heating & Cooling

DUCTED HEATING OUTLET 12

THEATING UNIT (IN ROOF) 1

HEATING CONTROL PANEL

HCP

ELECTRICAL SCHEDULE (HEATING & COOLING)

ELECTRICAL - HVAC
SCALE 1:100

PLEASE NOTE:
ALL ELECTRICAL FITTING/HEATING/COOLING OUTLET LOCATIONS ARE
NOMINAL ONLY. TO BE CONFIRMED AND LOCATED AS PER
MANUFACTURERS SPECIFICATIONS

HUDSON RIDGE B U I L D E R S HUDSON RIDGE BUILDERS 102 FUSSELL STREET, BALLARAT EAST 127 MARSHALLTOWN RD,GROVEDALE

e: sales@hudsonridge.com.au w: hudsonridge.com.au

COPYRIGHT HUDSON RIDGE BUILDERS
COPYRIGHT IN THIS DRAWING AND ALL WORKS EXECUTED FROM IT REMAINS THE PROPERTY OF HUDSON RIDGE BUILDERS
ANY REPRODUCTION OF ALL THESE DOCUMENTS MUST HAVE THE APPROVAL OF HUDSON RIDGE BUILDERS

NO RETURN TO THE PARTY OF THE P
¥

ELECTRICAL - HVAC	AREA DWELLING	SQM 259.02	SQ 27.88	REV.	DATE	AMENDMENT/DESIGN RELEASE	PROJECT NUMBER		BUSHFIRE RATING - BAL TBC SOIL CLASSIFICATION - "TBC"
CLIENT NAME: CLIENT NAME	GARAGE PORCH	38.94 3.69	4.19 0.40	REV #	*ISSUE DATE	*MANUAL TEXT* CONCEPT DESIGN	DATE:		WIND CLASSIFICATION - "TBC"
PROJECT ADDRESS: ADDRESS, SUBURB	TOTAL AREA: SITE AREA:	301.65 AREA	32.47				DRAWN BY:	SA	DRAWING NUMBER: 13 OF 21
DESIGN TYPE: GLASSHOUSE 32 ""MEREDITH""	SITE COVERAGE:	XX.X%					CHECKED BY:		PRINTED SHEET SIZE: A3

# WINDOW LIGHT AND VENTILATION SCHEDULE

ID	D01	D02	D03		D04	D05	W01	W	)2	W03	,	W04	W05	W06	V	W07	W08
ELEVATION						-											
ROOM	ENTRY	L'DRY	MASTER BED	l	IVING	RUMPUS	BED 2	KITCI	HEN	DINING	L	IVING	LIVING	LIVING	EN	ISUITE	ENSUITE
WINDOW TYPE	SWINGING DOOR	SWINGING DOOR	SLIDING DOOR	BI-PAR	TING DOOR	SLIDING DOOF	R AWNING; FIX	ED AWNING; FIXE	D; AWNING.	FIXED	AV	WNING	AWNING	AWNING	AW	VNING	AWNING
GLAZING/REVEAL TYPE	SG; SAFE; SR	SG; SAFE; SR	SG; SAFE; SR	SG;	SAFE; SR	SG; SAFE; SR	SG; SR	SG; SA	FE; SR	SG; SAFE; S	SR SG;	SAFE; SR	SG; SAFE; SR	SG; SAFE; SR	SG; S	SAFE; SR	SG; SAFE; TRANS;
HEIGHT	2,340	2,400	2,400		2,400	2,400	1,500	1,20	00	2,100		2,100	2,100	2,100	2	2,100	2,100
WIDTH	1,200	870	2,410		4,280	2,410	1,810	2,6	50	1,810		850	850	850	-	730	730
HEAD HEIGHT	2,340	2,400	2,400		2,400	2,400	2,400	2,4	00	2,400	í	2,400	2,400	2,400	2,	,400	2,400
SILL HEIGHT	0	0	0		0	0	900	1,20	00	300		300	300	300	3	300	300
REVEAL SIZE	100 (Weatherboard)	120 (Hebel Panel 200)	120 (Hebel Panel 200	)) 120 (Hel	pel Panel 200)	120 (Hebel Panel 2	200) 120 (Hebel Pa	nel 100 (Weath	nerboard)	100 (Weatherboa	1	lebel Panel 1 200)	20 (Hebel Panel 200)	120 (Hebel Pan 200)		ebel Panel	120 (Hebel Panel 200)
WINDOW FURNISHING	NO NO	NO NO	YES		YES	YES	YES	YE	S	YES	,	YES	YES	YES		YES	YES
ROOM AREA M2	SEE NOTES	3.86	SEE MASTER BED	SEI	E NOTES	SEE RUMPUS	11.80	SEE N	OTES	SEE NOTES	S SEE	NOTES	SEE NOTES	SEE NOTES	10	0.00	SEE ENSUITE
10% REQ LIGHT M2	SEE NOTES	0.39	SEE MASTER BED	SE	E NOTES	SEE RUMPUS	1.18	SEE N	OTES	SEE NOTES	S SEE	NOTES	SEE NOTES	SEE NOTES	1	1.00	SEE ENSUITE
ACTUAL LIGHT M2	1.75	1.41	4.81		8.59	4.81	2.21	2.5	51	3.42		1.37	1.37	1.37	1	1.13	1.13
5% REQ VENTILATION M2	SEE NOTES	0.19	SEE MASTER BED	SE	E NOTES	SEE RUMPUS	0.59	SEE N	OTES	SEE NOTES	S SEE	NOTES	SEE NOTES	SEE NOTES	(	0.50	SEE ENSUITE
ACTUAL VENTILATION M2	1.75	1.41	2.40		4.30	2.40	1.11	1.6	7	0.00		1.37	1.37	1.37	1	1.13	1.13
ID	W09	W10	W11	W12	W13	W14	W15	W16	W17		W18	W19	W2	0	W21	W22	W23
ELEVATION																	
ROOM	MASTER BED	MASTER BED	MASTER BED	MASTER BED	ENTRY	LIVING	KITCHEN	RUMPUS	RUMPU	JS I	RUMPUS	RUMPUS	BED	4	BED 3	STUDY	BATH
WINDOW TYPE	AWNING; FIXED	AWNING; FIXED	AWNING; FIXED	AWNING; FIXED	FIXED	FIXED	FIXED	AWNING; FIXED	AWNING; F		NING; FIXED	AWNING; FIX			NG; FIXED	AWNING	
GLAZING/REVEAL TYPE	SG; SAFE; SR	SG; SAFE;	; SR SG	G; SAFE; SR	SG; SAFE; S	R SG; S	SR S	SG; SR	SG; SAFE;	SR SG; SAFE; SI							
HEIGHT	2,100	2,100	2,100	2,100	2,100	2,100	2,100	2,100	2,100		2,100	2,100	1,20	0	1,200	2,100	900
WIDTH	1,510	1,510	1,010	1,010	1,010	1,010	1,010	1,010	1,010		1,510	1,510	1,81	0	1,810	730	1,510
HEAD HEIGHT	2,400	2,400	2,400	2,400	2,400	2,400	2,400	2,400	2,400	)	2,400	2,400	2,40	00	2,400	2,400	2,400
SILL HEIGHT	300	300	300	300	300	300	300	300	300	I	300	300	1,20	II	1,200	300	1,500
REVEAL SIZE	120 (Hebel Panel 200)	120 (Hebel 200)		(Hebel Panel 200)	120 (Hebel Pa 200)	anel 120 (Hebe 200		lebel Panel 200)	120 (Hebel F 200)	anel 120 (Hebel Pa 200)							
WINDOW FURNISHING	YES	YES	I	YES	YES	YES	,	YES	YES	YES							
ROOM AREA M2	SEE MASTER BED	SEE MASTER BED	26.65	SEE MASTER BED	SEE NOTES	SEE NOTES	SEE NOTES	SEE NOTES	SEE NOT	TES SE	E RUMPUS	16.80	11.19	9	11.19	4.20	5.77

۱۸/	INI	DC	۱۱۸/	KE	V٠

10% REQ LIGHT M2

ACTUAL LIGHT M2

5% REQ VENTILATION M2

ACTUAL VENTILATION M2

SG DG LOW-E SAFE

SEE MASTER BED

2.59

SEE MASTER BED

1.29

STANDARD PLASTER REVEAL TILED REVEAL TEMP BOTTOM REVEAL

KITCHEN / MEALS / LI	VING:
TOTAL ROOM AREAS	107.81 SQM
10% REQ LIGHT M2	10.78
ACTUAL LIGHT M2	28.50
5% REQ VETILATION M2	5.39
ACTUAL VENTILATION M2	11.89

0.42

1.13

0.21

1.13

0.58

1.02

0.29

0.51

**HUDSON RIDGE**B U I L D E R S

HUDSON RIDGE BUILDERS 102 FUSSELL STREET, BALLARAT EAST 127 MARSHALLTOWN RD,GROVEDALE

e: sales@hudsonridge.com.au w: hudsonridge.com.au

SEE MASTER BED

2.59

SEE MASTER BED

1.29

COPPINGHT HUDSON BIDGE BUILDES: COPPINGHT BUT BEAUTH BEAUTH BUT BEAUTH BUT BUT BEAUTH BUT BUT BUT BUT BUT BEAUTH BUT BUT BUT BUT BEAUTH BUT
---

2.09

1.71

1.33

0.55



SEE MASTER BED

1.71

SEE MASTER BED

0.55

SEE NOTES

1.82

SEE NOTES

0.00

SEE NOTES

1.82

SEE NOTES

0.00

VINDOW/DOOR SCHEDULE (	BUILT FORM AREAS AREA DWELLING	SQM 259.02	SQ 27.8
IENT NAME: CLIENT NAME	GARAGE PORCH TOTAL AREA:	38.94 3.69 301.65	4.19 0.40 32.4
OJECT ADDRESS: ADDRESS, SUBURB	SITE AREA: SITE COVERAGE	AREA XX.X%	32.4
SIGN TYPE: GLASSHOUSE 32 ""MEREDITH""	32 22 . 2.10 102.	70.2770	

SEE NOTES

1.82

SEE NOTES

0.00

SEE NOTES

1.71

SEE NOTES

0.55

SEE NOTES

1.71

SEE NOTES

0.55

SEE RUMPUS

2.59

SEE RUMPUS

1.29

	REV.	DATE		PROJECT NUMBER:		BUSHFIRE RATING - BAL TBC SOIL CLASSIFICATION - "TBC"
F	REV #	*ISSUE DATE	*MANUAL TEXT* CONCEPT DESIGN	TC DATE:		WIND CLASSIFICATION - "TBC"
-				DRAWN BY:	S A	DRAWING NUMBER: 14 OF 21
-				CHECKED BY:		PRINTED SHEET SIZE: A3

1.12

1.73

0.56

0.87

1.12

1.73

0.56


0.87


1.68

2.59

0.84

1.29

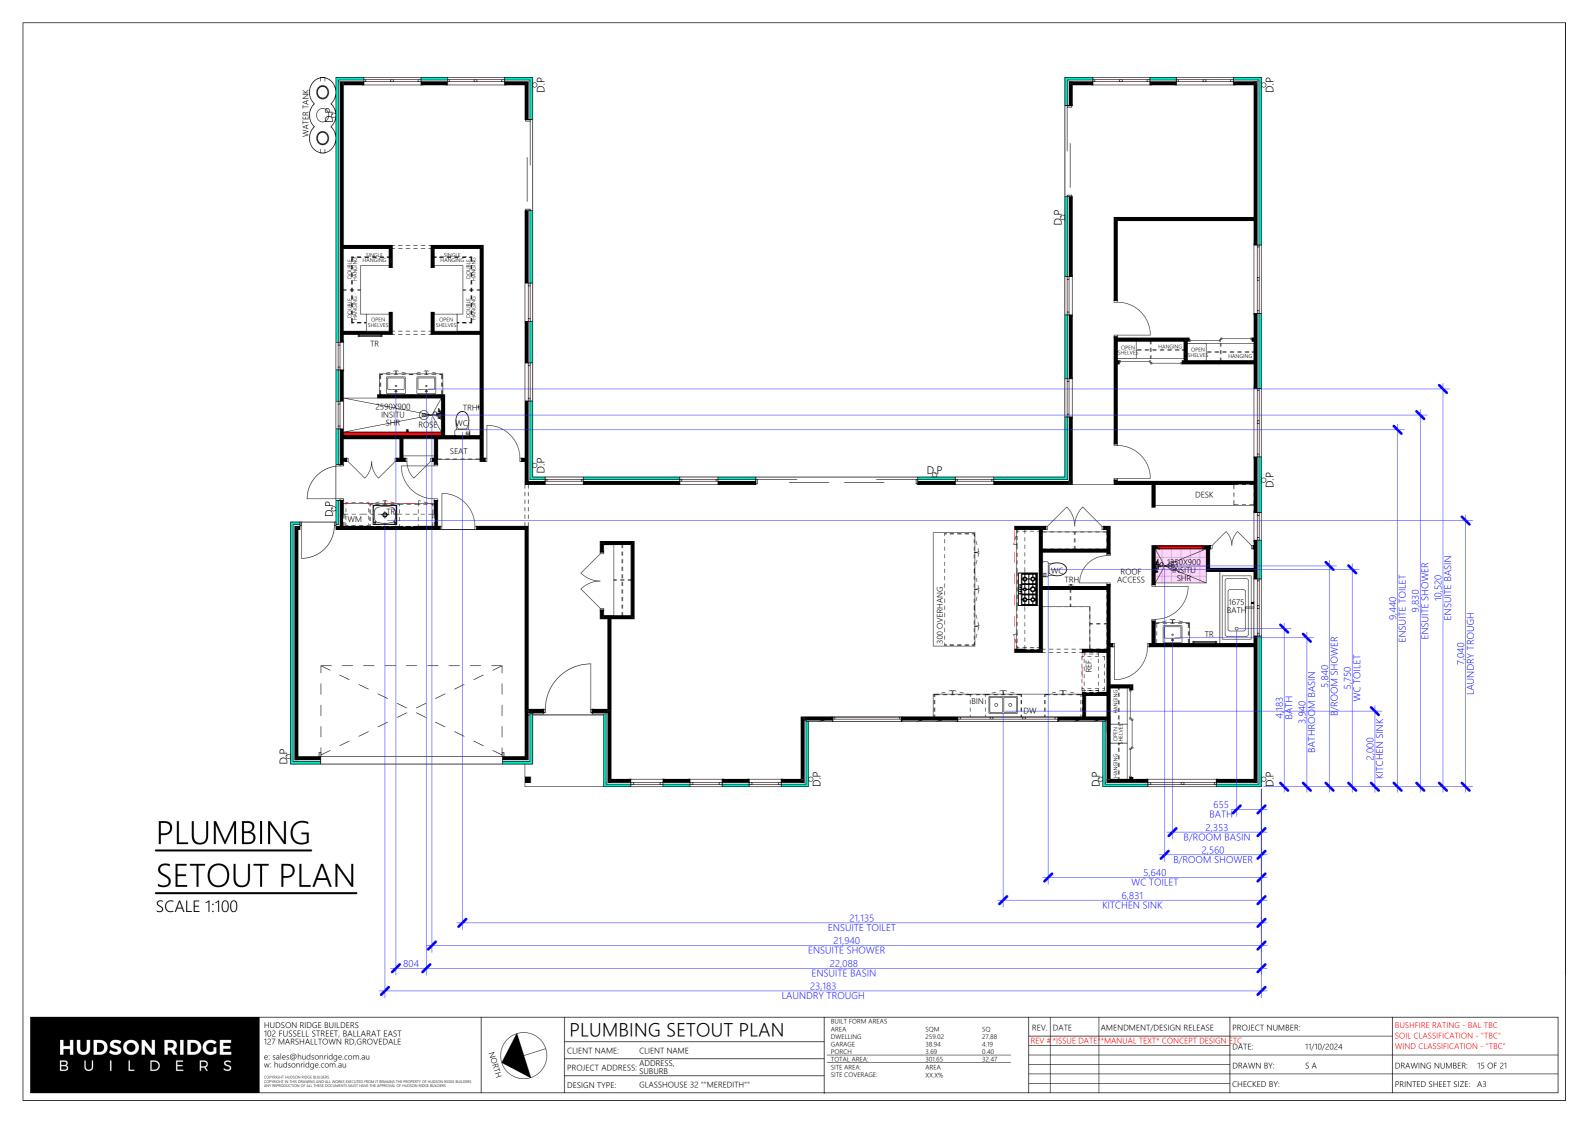

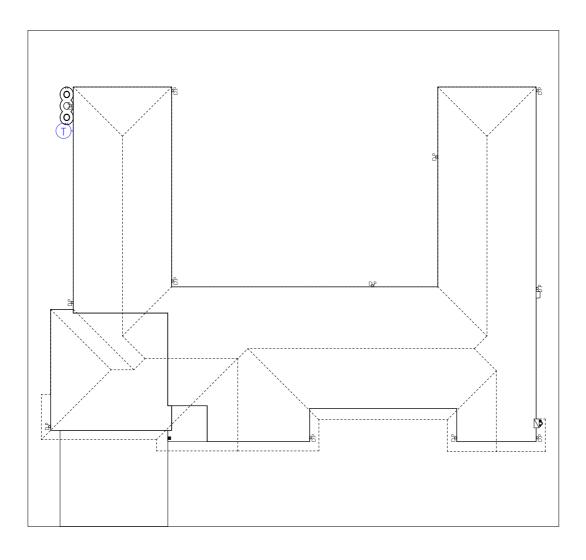

# CONCRETE SETOUT PLAN SCALE 1:200


HUDSON RIDGE B U I L D E R S

HUDSON RIDGE BUILDERS 102 FUSSELL STREET, BALLARAT EAST 127 MARSHALLTOWN RD,GROVEDALE



ONCR	ETE SETOUT PLAN	BUILT FORM AREAS AREA DWELLING	SQM 259.02	SQ 27.8
ENT NAME:	CLIENT NAME	GARAGE PORCH	38.94 3.69	4.19 0.40
OJECT ADDRESS	- ADDRESS, - SUBURB	TOTAL AREA: SITE AREA: SITE COVERAGE:	301.65 AREA XX.X%	32.4
SIGN TYPE:	GLASSHOUSE 32 ""MEREDITH""	SITE COVERNOE.	AA.A/0	

- 1				PROJECT NUMBER:		BUSHFIRE RATING - BAL TBC SOIL CLASSIFICATION - "TBC"
	REV #	*ISSUE DATE	*MANUAL TEXT* CONCEPT DESIGN	TC DATE:		WIND CLASSIFICATION - "TBC"
				DRAWN BY:	S A	DRAWING NUMBER: 16 OF 21
				CHECKED BY:		PRINTED SHEET SIZE: A3

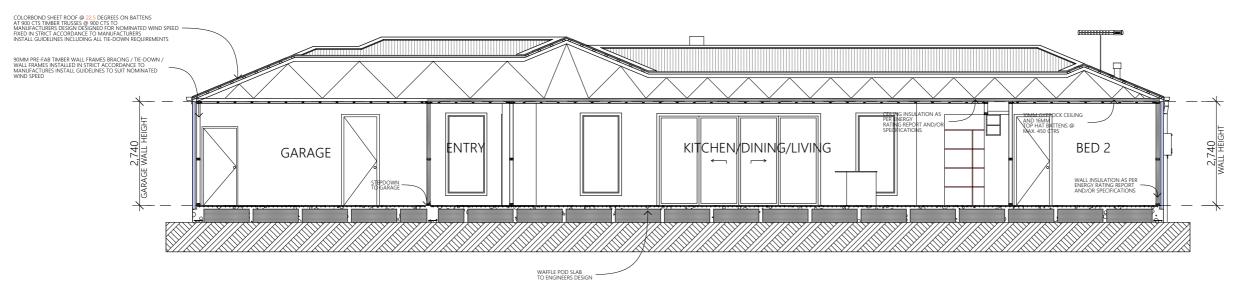

#### ENERGY RATING NOTES:

-MODIFICATIONS MAY BE NECESSARY TO ACHIEVE REQUIRED ENERGY EFFICIENCY SUBJECT TO FINAL ENERGY RATING REPORT

#### -DOOR SEALS

-BRUSH SEALS TO UTILITY ROOM DOORS. SILL SEALS TO EXTERNAL HINGED DOORS (INCL. GARAGE))

#### -DRAFT EXCLUSION

-WEATHER WRAPPED WITH TAPED HORIZONTAL AND VERTICAL JOINTS. SEALED GAPS AROUND WINDOWS AND EXTERNAL DOORS.

-EXHAUST FANS (SELF CLOSING AND VENTED TO OPEN AIR)
DRAFT PREVENTION TO EXHAUST FANS.

#### INSULATION

-CEILING INSULATION

R5.0 INSULATION BATTS

-BETWEEN FLOORS INSULATION


R-4.1 INSULATION BATTS

-WALL INSULATION

R-2.5 INSULATION BATTS

# SECTION A-A

SCALE 1:100

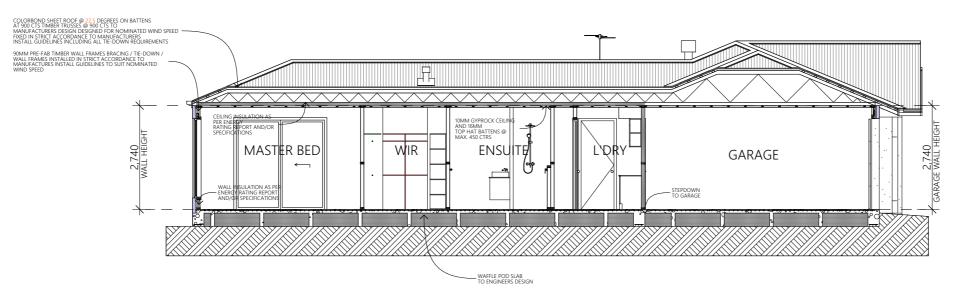

SECTION B-B SCALE 1:100

HUDSON RIDGE B U I L D E R S HUDSON RIDGE BUILDERS 102 FUSSELL STREET, BALLARAT EAST 127 MARSHALLTOWN RD,GROVEDALE


e: sales@hudsonridge.com.au w: hudsonridge.com.au

COPPIGHT HUDSON RIGGE BUILDERS
COPPIGHT IN THE DRAWING AND ALL WORKS EXECUTED FROM IT REMAINS THE PROPERTY OF HUDSON RIDGE BUILDI
ANY REPRODUCTION OF ALL THESE DOCLUMENTS MUST HAVE THE APPROVAL OF HUDSON RIDGE BUILDERS




SECTION AA & BB	BUILT FORM AREAS AREA DWELLING	SQM 259.02	SQ 27.
LIENT NAME: CLIENT NAME	GARAGE PORCH TOTAL AREA:	38.94 3.69 301.65	4.1 0.4 32.
ROJECT ADDRESS: ADDRESS, SUBURB	SITE AREA: SITE COVERAGE:	AREA XX.X%	32.
ESIGN TYPE: GLASSHOUSE 32 ""MEREDITH""	Site COVERNOE.	ACCA ACCA ACCA ACCA ACCA ACCA ACCA ACC	


			PROJECT NUMBER:		BUSHFIRE RATING - BAL TBC SOIL CLASSIFICATION - "TBC"
REV #	*ISSUE DATE	*MANUAL TEXT* CONCEPT DESIGN	TC DATE:		WIND CLASSIFICATION - "TBC"
			DRAWN BY:	S A	DRAWING NUMBER: 17 OF 21
			CHECKED BY:		PRINTED SHEET SIZE: A3

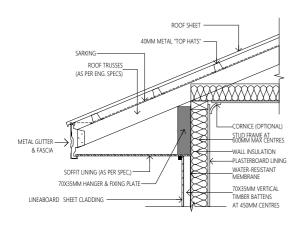


D1 ROOF EAVE DETAIL

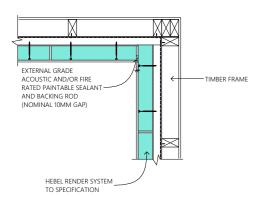


**D4 INTERNAL CORNER** 

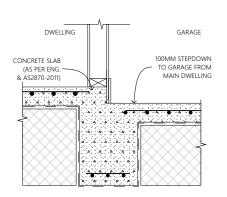


D8 TYPICAL 100MM STEPDOWN DETAIL

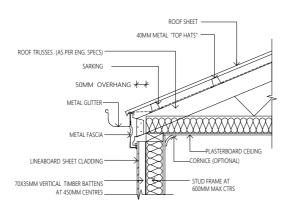


D2 PITCHED ROOF DETAIL

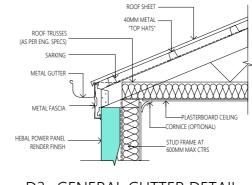


D3 GENERAL GUTTER DETAIL

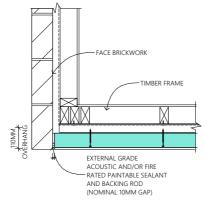


D5 EXTERNAL CORNER

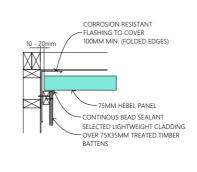


**D6 INTERNAL CLADDING JUNCTION** HEBEL & LIGHTWEIGHT CLADDING

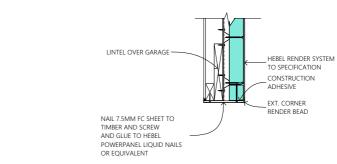


D7 GARAGE DOOR **HEAD DETAIL** 

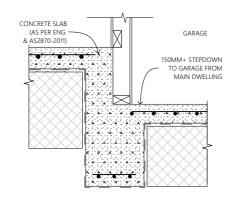



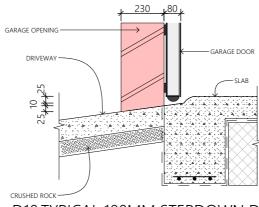

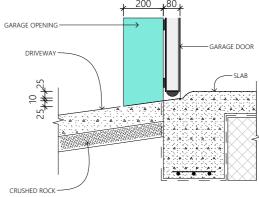

D11 TYPICAL 100MM STEPDOWN DETAIL

**HUDSON RIDGE** BUILDERS HUDSON RIDGE BUILDERS 102 FUSSELL STREET, BALLARAT EAST 127 MARSHALLTOWN RD,GROVEDALE e: sales@hudsonridge.com.au w: hudsonridge.com.au

DETAILS	5 01	BUILT FORM AREAS AREA DWELLING	SQM 259.02	SQ 27.88
CLIENT NAME:	CLIENT NAME	GARAGE PORCH	38.94 3.69	4.19 0.40
PROJECT ADDRESS	S: ADDRESS, SUBURB	TOTAL AREA: SITE AREA: SITE COVERAGE:	301.65 AREA XX.X%	32.47
DESIGN TYPE:	GLASSHOUSE 32 ""MEREDITH""	SITE COVERNOL.	AA.A/0	

		,	PROJECT NOWIDER.		BUSHFIRE RATING - BAL TBC SOIL CLASSIFICATION - "TBC" WIND CLASSIFICATION - "TBC"	
EV #	*ISSUE DATE	*MANUAL TEXT* CONCEPT DESIGN				
			DRAWN BY:	S A	DRAWING NUMBER: 18 OF 21	
			CHECKED BY:		PRINTED SHEET SIZE: A3	

### REINFORCMENT OF BATHROOM AND SANITARY COMPARTMENT WALLS

Location of noggings for walls surrounding a bath

Light gauge steel framing noggings or metal plate in accordance with the NASH Standard.

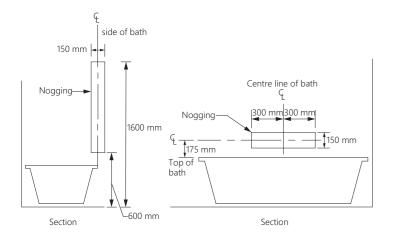


Figure Notes

- (1) Taps, bath niches, soap holders and the like may be located within the positions designated for wall reinforcing.
- (2) Where the height of the bathtub is not yet known, an assumed height of 500 mm above finished floor level may be used to determine the location of wall reinforcing.

Location of sheeting for walls surrounding a bath

Location of noggings for shower walls

Where the height of the bath tub is not yet known, an assumed height of 500 mm above finished floor level may be used to determine the location of wall reinforcing.


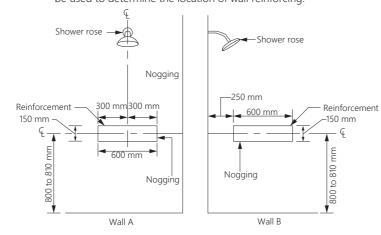


Figure Notes

Taps, bath niches, soap holders and the like may be located within the positions designated for wall reinforcing.

Location of noggings for a wall behind a toilet pan

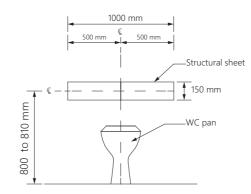

Location of sheeting for walls surrounding a bath


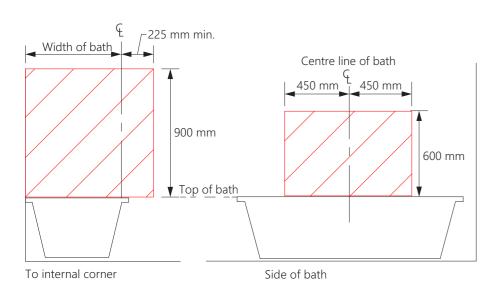


Figure Notes

(1) Taps, bath niches, soap holders and the like may be located within the positions designated for wall reinforcing.

#### Location of sheeting for shower walls

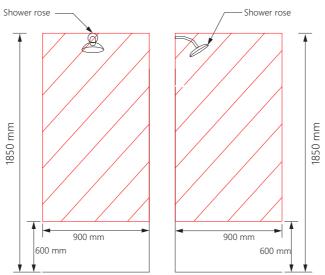

igure Notes

Taps, bath niches, soap holders and the like may be located within the positions designated for wall reinforcing.

#### Minimum extent of sheeting for wall adjacent to a toilet pan

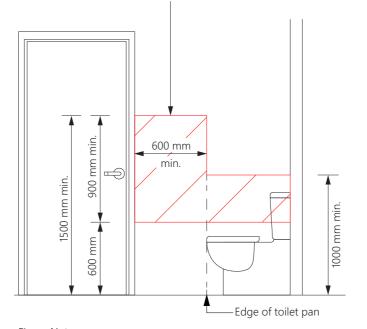


Figure Notes

Minimum extent of structural sheeting clear of any door frame, window frame or wall opening

#### Location of sheeting for a wall behind a toilet pan

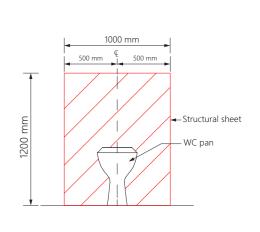


Figure Notes

Minimum extent of structural sheeting clear of any door frame, window frame or wall opening

HUDSON RIDGE B U I L D E R S HUDSON RIDGE BUILDERS 102 FUSSELL STREET, BALLARAT EAST 127 MARSHALLTOWN RD,GROVEDALE e: sales@hudsonridge.com.au

W: hudsonridge.com.au coprisisht hubson ribde Builders coprisisht in this drawing and all works blecuted from it remains the property of hubson NORTH CORNEL

BATHROOM DETAILS	BUILT FORM AREAS AREA DWELLING	SQM 259.02	SQ 27.88
CLIENT NAME: CLIENT NAME	GARAGE PORCH	38.94 3.69	4.19 0.40
PROJECT ADDRESS: ADDRESS, SUBURB	TOTAL AREA: SITE AREA: SITE COVERAGE:	301.65 AREA XX.X%	32.47
DECICNITYDE. CLASSHOLISE 22 ""MEDEDITH""	SITE COVERNOE.	AA.A/0	

EV.	DATE	AMENDMENT/DESIGN RELEASE	TC :		BUSHFIRE RATING - BAL TBC SOIL CLASSIFICATION - "TBC" WIND CLASSIFICATION - "TBC"	
V #	*ISSUE DATE	*MANUAL TEXT* CONCEPT DESIGN				
			DRAWN BY:	S A	DRAWING NUMBER: 19 OF 21	
			CHECKED BY:		PRINTED SHEET SIZE: A3	

PART 10.2 WET AREA WATERPROOFING

10..2.1 WET AREAS

1) BUILDING ELEMENTIN WET AREAS WITHIN A BUILDING MUST BE PROTECTED WITH A WATERPROOFING SYSTEM

2) THE WATERPROFING SYSTEM IN(1) MUST BE EITHER WATERPROOF OR WATER

RESISTANT IN ACCORDANCE WITH 10.2.2 TO 10.2.6


10.2.21 MEMBRANE INSTALLATION FOR SCREED WHERE SCREED IS USED IN CONJUNCTION WITH A WATERPROOF MEMBRANE, THE WATERPROOF MEMBRANE CAN BE INSTALLED EITHER ABOVE OR BELOW THE TILE BED OR SCREED

10.2.22 SUBSTRATE SURFACE PREPERATION FOR APPLICATION OF MEMBRANE WHERE FLOORS FALL TO FLOOR WASTES IN A WET AREA, THE SUBSTRATE IS NOT REQUIRED TO HAVE ANY FALL MUST BE:

- CLEAN AND DUST FREE & - FREE OF INDENTATIONS AND IMPERFECTIONS

10.2.6 WATERPROOFING SYSTEMS

WATERPROOFING SYSTEM REQUIRED TO BE WATERPROOF IN ACCORDANCE WITH 10.2.2 TO 10.2.5, THE MATERIALS MUST BE NOMINATED IN 10.2.8 MUST BE USED

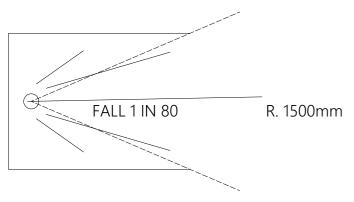


#### (TYPICAL) CAST-IN SHOWER DETAIL SCALE 1:20

OPEN SHOWERS (INCL. SCREENS AND DOORS) THE FLOOR TO BE GRADED @ 1:80 FALL TO A FLOOR WASTE WITHIN 1500mm FROM THE SHOWER OUTLET

NOTE: PROVIDE ONE HOBLESS AND STEP DOWN SHOWER ON GROUND FLOOR


10.2.2 SHOWER AREA (ENCLOSED AND UNENCLOSED)

FIGURE 10.2.2

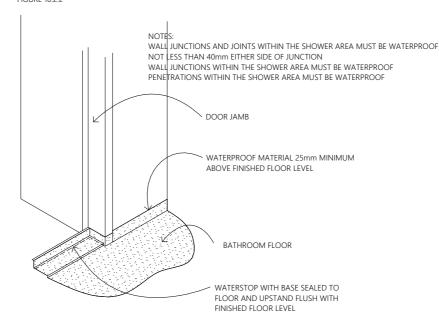


#### TYPICAL BATHROOM DOOR DETAIL

ALL WET AREAS TO BE IN ACCORDANCE WITH BCA 2022 PART 10.2 WET AREA WATERPROOFING

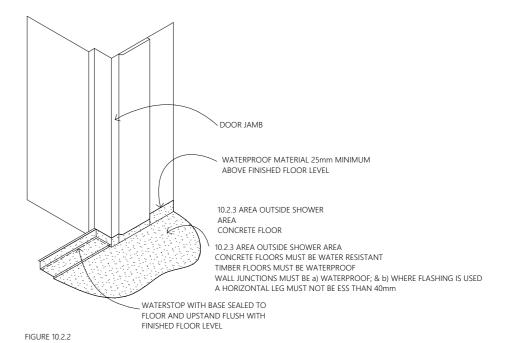


#### TYPICAL BATHROOM DOOR DETAIL

ALL WET AREAS TO BE IN ACCORDANCE WITH BCA 2022 PART 10.2 WET AREA WATERPROOFING

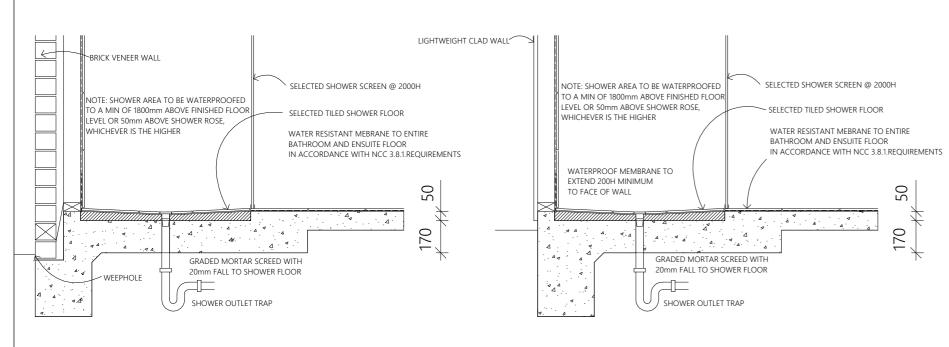

#### TYPICAL CAST-IN SHOWER DETAIL

ALL WET AREAS TO BE IN ACCORDANCE WITH BCA 2022 PART 10.2 WET AREA WATERPROOFING

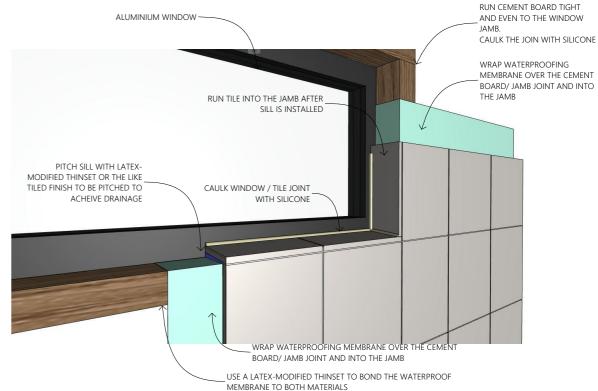

#### WATERPROOFING WINDOW IN SHOWER

ALL WET AREAS TO BE IN ACCORDANCE WITH BCA 2022 PART 10.2 WET AREA WATERPROOFING

**HUDSON RIDGE** BUILDERS

TYPICAL CAST-IN SHOWER DETAIL

ALL WET AREAS TO BE IN ACCORDANCE WITH BCA 2022 PART 10.2 WET AREA WATERPROOFING

HUDSON RIDGE BUILDERS 102 FUSSELL STREET, BALLARAT EAST 127 MARSHALLTOWN RD,GROVEDALE



BATHRO	OOM DETAILS	BUILT FORM AREAS AREA DWELLING	SQM 259.02	SQ 27.88
CLIENT NAME:	CLIENT NAME	GARAGE PORCH TOTAL AREA:	38.94 3.69 301.65	4.19 0.40 32.47
PROJECT ADDRESS	- ADDRESS, SUBURB	SITE AREA: SITE COVERAGE	AREA XX.X%	32.41
DESIGN TYPE:	GLASSHOUSE 32 ""MEREDITH""	3112 COVERNICE.	ACAA	

	REV.	DATE	AMENDMENT/DESIGN RELEASE	PROJECT NUMBER.		BUSHFIRE RATING - BAL TBC SOIL CLASSIFICATION - "TBC"	
	REV #	*ISSUE DATE	*MANUAL TEXT* CONCEPT DESIGN	TC DATE:		WIND CLASSIFICATION - "TBC"	
-				DRAWN BY:	S A	DRAWING NUMBER: 20 OF 21	
				CHECKED BY:		PRINTED SHEET SIZE: A3	

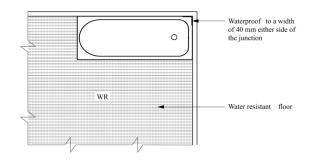


FIGURE 10.2.4a & b AREAS ADJACENT TO BATHS -

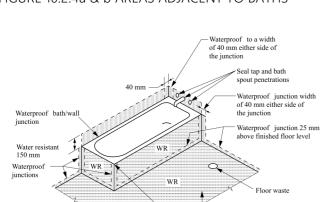


FIGURE 10.2.4a & b AREAS ADJACENT TO BATHS -

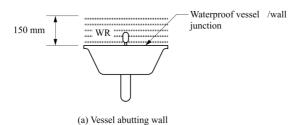


FIGURE 10.2.5 VESSEL ABUTTING WALL -

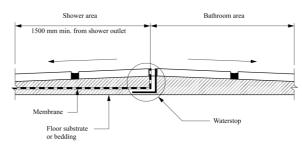


FIGURE 10.2.18 TYPICAL TERMINATION OF MEMBRANE AT EXTENT OF SHOWER AREA

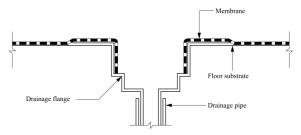


FIGURE 10.2.29 TYPICAL MEMBRANE TERMINATION AT DRAINAGE OUTLET

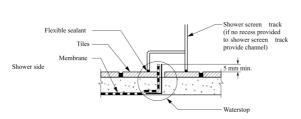


FIGURE 10.2.17 TYPICAL HOBLES CONSTRUCTION

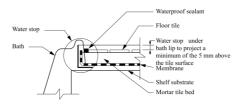


FIGURE 10.2.20 BATH - SHELF JUNCTION

PART 10.2 WET AREA WATERPROOFING
10..2.1 WET AREAS

1) BUILDING ELEMENTIN WET AREAS WITHIN A BUILDING MUST BE PROTECTED WITH A
WATERPROOFING SYSTEM
2) THE WATERPROFING SYSTEM IN(1) MUST BE EITHER WATERPROOF OR WATER
RESISTANT IN ACCORDANCE WITH 10.2.2 TO 10.2.6

10.2.21 MEMBRANE INSTALLATION FOR SCREED
WHERE SCREED IS USED IN CONJUNCTION WITH A WATERPROOF MEMBRANE, THE
WATERPROOF MEMBRANE CAN BE INSTALLED EITHER ABOVE OR BELOW THE TILE BED OR SCREED

10.2.22 SUBSTRATE SURFACE PREPERATION FOR APPLICATION OF MEMBRANE WHERE FLOORS FALL TO FLOOR WASTES IN A WET AREA, THE SUBSTRATE IS NOT REQUIRED TO HAVE ANY FALL MUST BE:

- CLEAN AND DUST FREE & - FREE OF INDENTATIONS AND IMPERFECTIONS

10.2.6 WATERPROOFING SYSTEMS
WATERPROOFING SYSTEM REQUIRED TO BE WATERPROOF IN ACCORDANCE WITH 10.2.2 TO 10.2.5,
THE MATERIALS MUST BE NOMINATED IN 10.2.8 MUST BE USED
FOR A WATERPROOFING


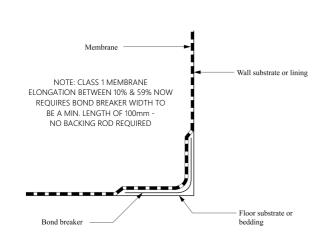


FIGURE 10.2.27 TYPICAL BOND BREAKER DETAIL

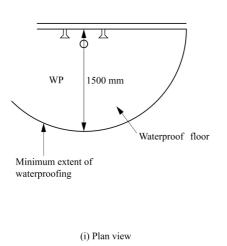

1800 mm

Waterproof wall

(ii) Side view

1500 mm

FIGURE 10.2.2(b) UNENCLOSED SHOWER



HUDSON RIDGE BUILDERS 102 FUSSELL STREET, BALLARAT EAST 127 MARSHALLTOWN RD,GROVEDALE e: sales@hudsonridge.com.au w: hudsonridge.com.au

sycone secura interior



BATHROOM DETAILS	BUILT FORM AREAS AREA DWELLING	SQM 259.02	SQ 27.88
CLIENT NAME: CLIENT NAME	GARAGE PORCH	38.94 3.69	4.19 0.40
PROJECT ADDRESS: ADDRESS, SUBURB	TOTAL AREA:  SITE AREA:  SITE COVERAGE	301.65 AREA XX.X%	32.47
DESIGN TYPE: GLASSHOUSE 32 ""MEREDITH""		75.770	

		,	PROJECT NOWIDER.		BUSHFIRE RATING - BAL TBC SOIL CLASSIFICATION - "TBC" WIND CLASSIFICATION - "TBC"	
#	*ISSUE DATE	*MANUAL TEXT* CONCEPT DESIGN				
-			DRAWN BY:	SA	DRAWING NUMBER: 21 OF 21	
7			CHECKED BY:		PRINTED SHEET SIZE: A3	